

Phone: 519-621-2761 Toll free: 1-866-900-4722 Fax: 519-621-4844 www.grandriver.ca

June 27, 2024

Magda Cober 109 Edgehill Drive Kitchener, ON N2P 2C6 by email

Re: Application for Permission No. 391/24, Pursuant to Ontario Regulation 41/24.

The Grand River Conservation Authority approved your application on June 25, 2024. The permit and attached schedules are enclosed. The schedules form part of the permit and describe the work as approved by the Grand River Conservation Authority. Any changes to these plans must be reviewed and approved by Grand River Conservation Authority staff.

Please note that this permission is based on existing information, policies, and practices, and does not bind nor imply that any other permission will be forthcoming. Please review when the permit expires as per the attached permit and keep a copy of the permit on-site.

If you have questions regarding this letter or the conditions described on the permit, please contact Andrew Herreman, Resource Planner, at (519) 621-2763 Extension 2228.

Encl.

c.c. Clerk, City of Kitchener
Building Inspector, City of Kitchener



Grand River Conservation Authority

Under Ontario Regulation 41/24 made under the Conservation Authorities Act, R.S.O. 1990, c. C.27, permission is granted to:

Magda Cober

Whose address for purposes pertaining to this project is:

109 Edgehill Drive Kitchener, ON N2P 2C6

To execute proposed works in accordance with the following particulars and conditions:

Location of Work: 109 Edgehill Drive

City of Kitchener

Purpose of Work: To install a pool, landscaping wall, and construct a

residential accessory building

This permit is valid from: June 25, 2024

and expires on: June 25, 2026

The attached Schedules form parts of this permit describing the approved work and must be implemented in order so that the true intent of the permit can be achieved.

The Permittee, by acceptance and in consideration of the issuance of this permit, agrees to the conditions listed on the reverse side of Schedule "A".

Dated at Cambridge, Ontario, this 25th day of June, 2024

GRAND RIVER CONSERVATION AUTHORITY

Samantha Lawson,

Chief Administrative Officer

GRCA USE ONLY APPLICATION NUMBER 391/24

Schedule "A" - Application for Permit Pursuant to Ontario Regulation 41/24

(Prohibited Activities, Exemptions and Permits Regulation)

Please read, complete each section as required, attach fee payment and sign and date this application. Payment must be addressed to the Grand River Conservation Authority. Applications can be mailed to:

Grand River Conservation Authority Administration Office

400 Clyde Road, P.O. Box 729, Cambridge, Ontario N1R 5W6 Telephone: 519-621-2761 Fax: (519) 621-4945

Own	ner's Contact Information:	
Name:	Magda Cober	E-mail: magda.cober@gmail.com
Mailing .	Address: 109 Edgehill Drive	City/Town: Kitchener
Postal C	Code: N2P 2C6	Business Telephone:
Resider	ntial Telephone: 5194966566	Fax:
Agent/0	Consultant/Contractor's Contact Information	1
Name:		E-mail:
Mailing Address:		City/Town:
Postal C	Code:	Business Telephone:
Residential Telephone:		Fax:
Locatio	on of Proposed Work:	
	al Address: 109 Edgehill Drive, Kitchener	
City/Tov	vn/Village: CITY OF KITCHENER	County/Region: REGIONAL MUNICIPALITY OF
Lot and Concession:		Township:
Applica	ation Type (check which applies). Refer to Fe Minor Development	ee Schedule on Pages 3 and 4.
	□ Minor Interference with Wetlands, Alteration to Shorelines & Watercourses	
	Standard Development	
	Standard Interference with Wetlands, Alteration	on to Shorelines & Watercourses
	Major Development	
	Major Interference with Wetlands Alteration t	o Shorelines & Watercourses

Chada wasan wasaha and auth ildiana		
Sheds, garages, gazebo and outbuildings		
	nust include appropriate plan(s) s is encouraged to confirm require	
Current Land Use: Residential		
Proposed Change in Use (if a	ny):	
I declare that I have read and a form and that all information pr	agree to the General Conditions ovided is true.	of Permit on the reverse of this
Signature of Owner:	Date:	

GENERAL CONDITIONS OF PERMIT

- 1. This permit does not absolve the permittee of the responsibility of obtaining necessary permission from applicable federal and provincial agencies or local municipalities.
- 2. The permittee agrees by acceptance of the permit:
 - (a) to indemnify and save harmless, the Grand River Conservation Authority and its officers, employees, or agents, from and against all damage, injury, loss, costs, claims, demands, actions and proceedings, arising out of or resulting from any act or omission of the permittee or of any of his agents, employees or contractors relating to any of the particular terms or conditions of this permit.
 - (b) that this permit shall not release the permittee from any legal liability or obligation and remains in force subject to all limitations, requirements and liabilities imposed by law.
 - (c) that all complaints arising from the proposed works authorized under this permit shall be reported immediately by the permittee to the Grand River Conservation Authority. The permittee shall indicate any action which has been taken, or is planned to be taken, with regard to each complaint.
 - (d) to provide certification of conformance to ensure compliance with the intent of the permit. This certification must be provided by an accredited professional and is to be submitted as may be specified in the permit.
- 3. Authorized representatives of the Grand River Conservation Authority will be granted entry at any time into lands which are the subject of this permit application in order to make such surveys, examinations, investigations, inspections or other arrangements which such representatives deem necessary.
- 4. The Grand River Conservation Authority may add conditions of approval or cancel this permit in accordance with the *Conservation Authorities Act* and/or Ontario Regulation 41/24.
- 5. This permit shall not be reassigned (non-transferable).
- 6. Permits are valid for up to two years unless otherwise noted on the permit. The maximum period of validity of a permit, including extensions, is 60 months. No notice will be issued on expiration of the permit, and it is the responsibility of the permittee to ensure a valid permit is in effect at the time work is occurring.
- 7. Requests to consider a permit extension must be received 60 calendar days before the expiry date on the permit.
- 8. The Grand River Conservation Authority may make copies of Schedule A and materials submitted in conjunction with Schedule A, as required, for the purposes of assessing the proposal and, where approved, to form part of the permit issued.
- 9. The Grand River Conservation Authority may request that GIS data files be submitted as part of Schedule A, to be used for business purposes pursuant to Regulation 41/24.

NOTICE OF COLLECTION

Pursuant to section 29(2) of the Municipal Freedom of Information and Protection of Individual Privacy Act R.S.O 1990, C.M.56 the personal information contained on this form is collected under the legal authority of the Conservation Authorities Act, R.S.O. 1990, c.27, as amended. This information is used to assess applications for and, where approved, issue the Permit. Information on this form may be disclosed to Government and Municipal Agencies for review and comment. The name of the applicant, location of the work and a description of the project may be published in GRCA documents including agendas, reports and meeting minutes which are posted on the GRCA website. Questions about the collection of personal information should be directed to the Freedom of Information Coordinator, Administration Division, Grand River Conservation Authority, 400 Clyde Road, P.O. Box 729, Cambridge, Ontario, N1R 5W6, (519) 621-2761.

GRCA Permit, Plan Review, Title Clearance, and Inquiry Fee Schedule 2023-2024

Please refer to the **Fee Notes** outlined below for more details.

Permit Fee Schedule Note: Applicants are encouraged to apply online on the GF	RCA Permits Application Page.
Minor - Low risk of impact on natural hazards or natural feat	ure. No technical reports required
Fee for Development Applications	\$465
Fee for Alterations or Interference with Wetlands,	\$465
Shorelines and Watercourses Applications	
Standard - Moderate risk and/or potential impact on natural and/or plans, site visit required	hazards or natural features. Detailed report
Fee for Development Applications	\$675
Fee for Alterations or Interference with Wetlands,	\$1,185
Shorelines and Watercourses Applications	
Major - Requires one or more reports (Environmental Impac Management, Geotechnical, etc.)	t Study, Hydraulic Analysis, Stormwater
Fee for Development Applications	\$10,230
Fee for Alterations or Interference with Wetlands,	Culvert/Bridge replacement
Shorelines and Watercourses Applications	\$6,710
	All other applications
	\$10,230
Large Fill - over 1,000m ³	\$10,230 plus \$0.50/m ³
Works initiated prior to GRCA approval	2 times the fee for the category
Rural Water Quality Programs or GRCA projects	\$90
Permit Extension	\$90
Plans amended to an approved permit	\$90

Inquiry Schedule	
Title Clearance, Real Estate, and other Inquiry Fee (per	\$255/property
request)	

Plan Rev	iew Fee Schedule		
Subdivision and Vacant Land Condominium			
•	Base fee	\$2,505	
•	Per net hectare	\$1,305/hectare	
•	Applicant driven modification	\$1,670	
•	Final clearance for registration of each stage: technical review required	\$6,708	
•	Final clearance Processing Fee: no reports or review required	\$255	
•	Fourth (4 th) and subsequent submission for review (same report)	\$575	


Plan Review Fee Schedule	
Official Plan and/or Zoning Bylaw Amendment	
Major	\$2,500
Minor	\$465
Consent	
Major	\$1,185
Minor	\$465
Minor Variances	
Major	\$675
Minor	\$300
Site Plan Approval Applications	
 Major 	\$3,515
Minor	\$465
Complex Applications	\$10,230
Below Water Table Aggregate Applications	
 No features of interest within 30 metres 	s of licence limit \$10,230
 Features of interest within 30 metres or 	f licence limit \$42,850
Above Water Table Aggregate Applications	
 No features of interest within 30 metres 	s of licence limit \$465
 Features of interest within 30 metres or 	f licence limit \$10,230

2024 Fee Notes

On April 1, 2024, the Prohibited Activities, Exemptions and Permits Regulation (Ontario Regulation 41/24) came into effect. This regulation replaces the Development, Interference with Wetlands and Alterations to Shorelines and Watercourses Regulation (Ontario Regulation 150/06). This Fee Schedule was updated on April 26, 2024 to reflect changes resulting from the new Regulation.

- 1. All fees are made payable and submitted directly to Grand River Conservation Authority.
- 2. Applicants are encouraged to consult with staff prior to submission of all applications to determine the extent and nature of the information required to accompany the application, and to determine the appropriate fee.
- 3. Applicants are encouraged to submit Permit applications through <u>the GRCA's online Permit</u> **Application System** after pre-submission consultation where appropriate.
- 4. Permit applications that fall into one or more categories will be charged one fee, at the highest rate.
- 5. Plan review applications that fall into one or more categories will be charged one fee, at the highest rate.
- 6. The Conservation Authority may provide a refund or require the applicant submit additional funds for a permit or plan review fee if it is found that an incorrect fee has been submitted.
- 7. Minor Categories Low risk of impact on natural hazards. Plans required. No technical reports or site visits required.
- 8. Standard Permit Category Moderate hazard risk and/or potential impact on natural hazards. Detailed plans required. Scoped technical reports and/or site visits required.
- 9. Major Permit Category– High hazard risk and/or potential impact to natural hazards. Detailed plans required. One or more technical report required (Environmental Impact Study, Hydraulic Analysis, Storm Water Management, Geotechnical, etc.). Development permit applications for: golf courses, trailer parks, campgrounds, lifestyle communities will be considered as a major permit.
- 10. Major Plan Review Category– High or Moderate hazard risk and/or potential impact on natural hazards s. Detailed plans required. One or more technical reports (may be scoped) are required, and a site visit may be required.
- 11. Complex Plan Review Category Planning Act (e.g. OPA/ZC) and/or Site plan applications for: golf courses, trailer parks, campgrounds, lifestyle communities.
- 12. Large Fill The fee is applicable to material placed within the Conservation Authority's regulated areas. Grading associated with Planning Act approvals is not considered a large fill application.
- 13. Major permit applications that have previously paid application or clearance plan review fees to the GRCA will be charged fees under the Minor or Standard category.
- 14. Permit fees are non-refundable, except where review indicates that no permit is necessary.
- 15. Permit Extension Permits are valid for up to 24 months unless otherwise specified on the permit. An application for an extension is \$90 and must be requested at least 60 calendar days before the expiry of the permit. Extensions will not be granted after the expiry date and will require a new application, full review, and the Schedule of Fees in effect at the time of submission will apply. The maximum period of validity of a permit, including extensions, is 60 months.

- 16. The subdivision or vacant land condominium base fee including per net hectare fee will be capped at \$30,000.
- 17. The net hectare fee will be based on the initial submission and will exclude lands outside of the development limit (e.g. natural hazard, natural heritage areas and buffers). Stormwater management facilities and other open space or park uses are to be included in the net hectare fee calculation.
- 18. At the submission of a subdivision or vacant land condominium application, 70% of the base fee and per net hectare is required. Prior to issuance of conditions of draft plan approval, the remaining 30% of the fee is required.
- 19. A Processing Fee will apply for a clearance letter for a subdivision or condominium application where no technical review/reports (e.g. no Erosion and Sediment Control plan, SWM brief, etc.) are required.
- 20. For Aggregate Applications, features of interest include all natural hazards including wetlands and watercourses.
- 21. Responses to Title Clearances, Real Estate and other Inquiries includes: Correspondence and mapping related to natural hazards and areas regulated under Ontario Regulation 41/24.

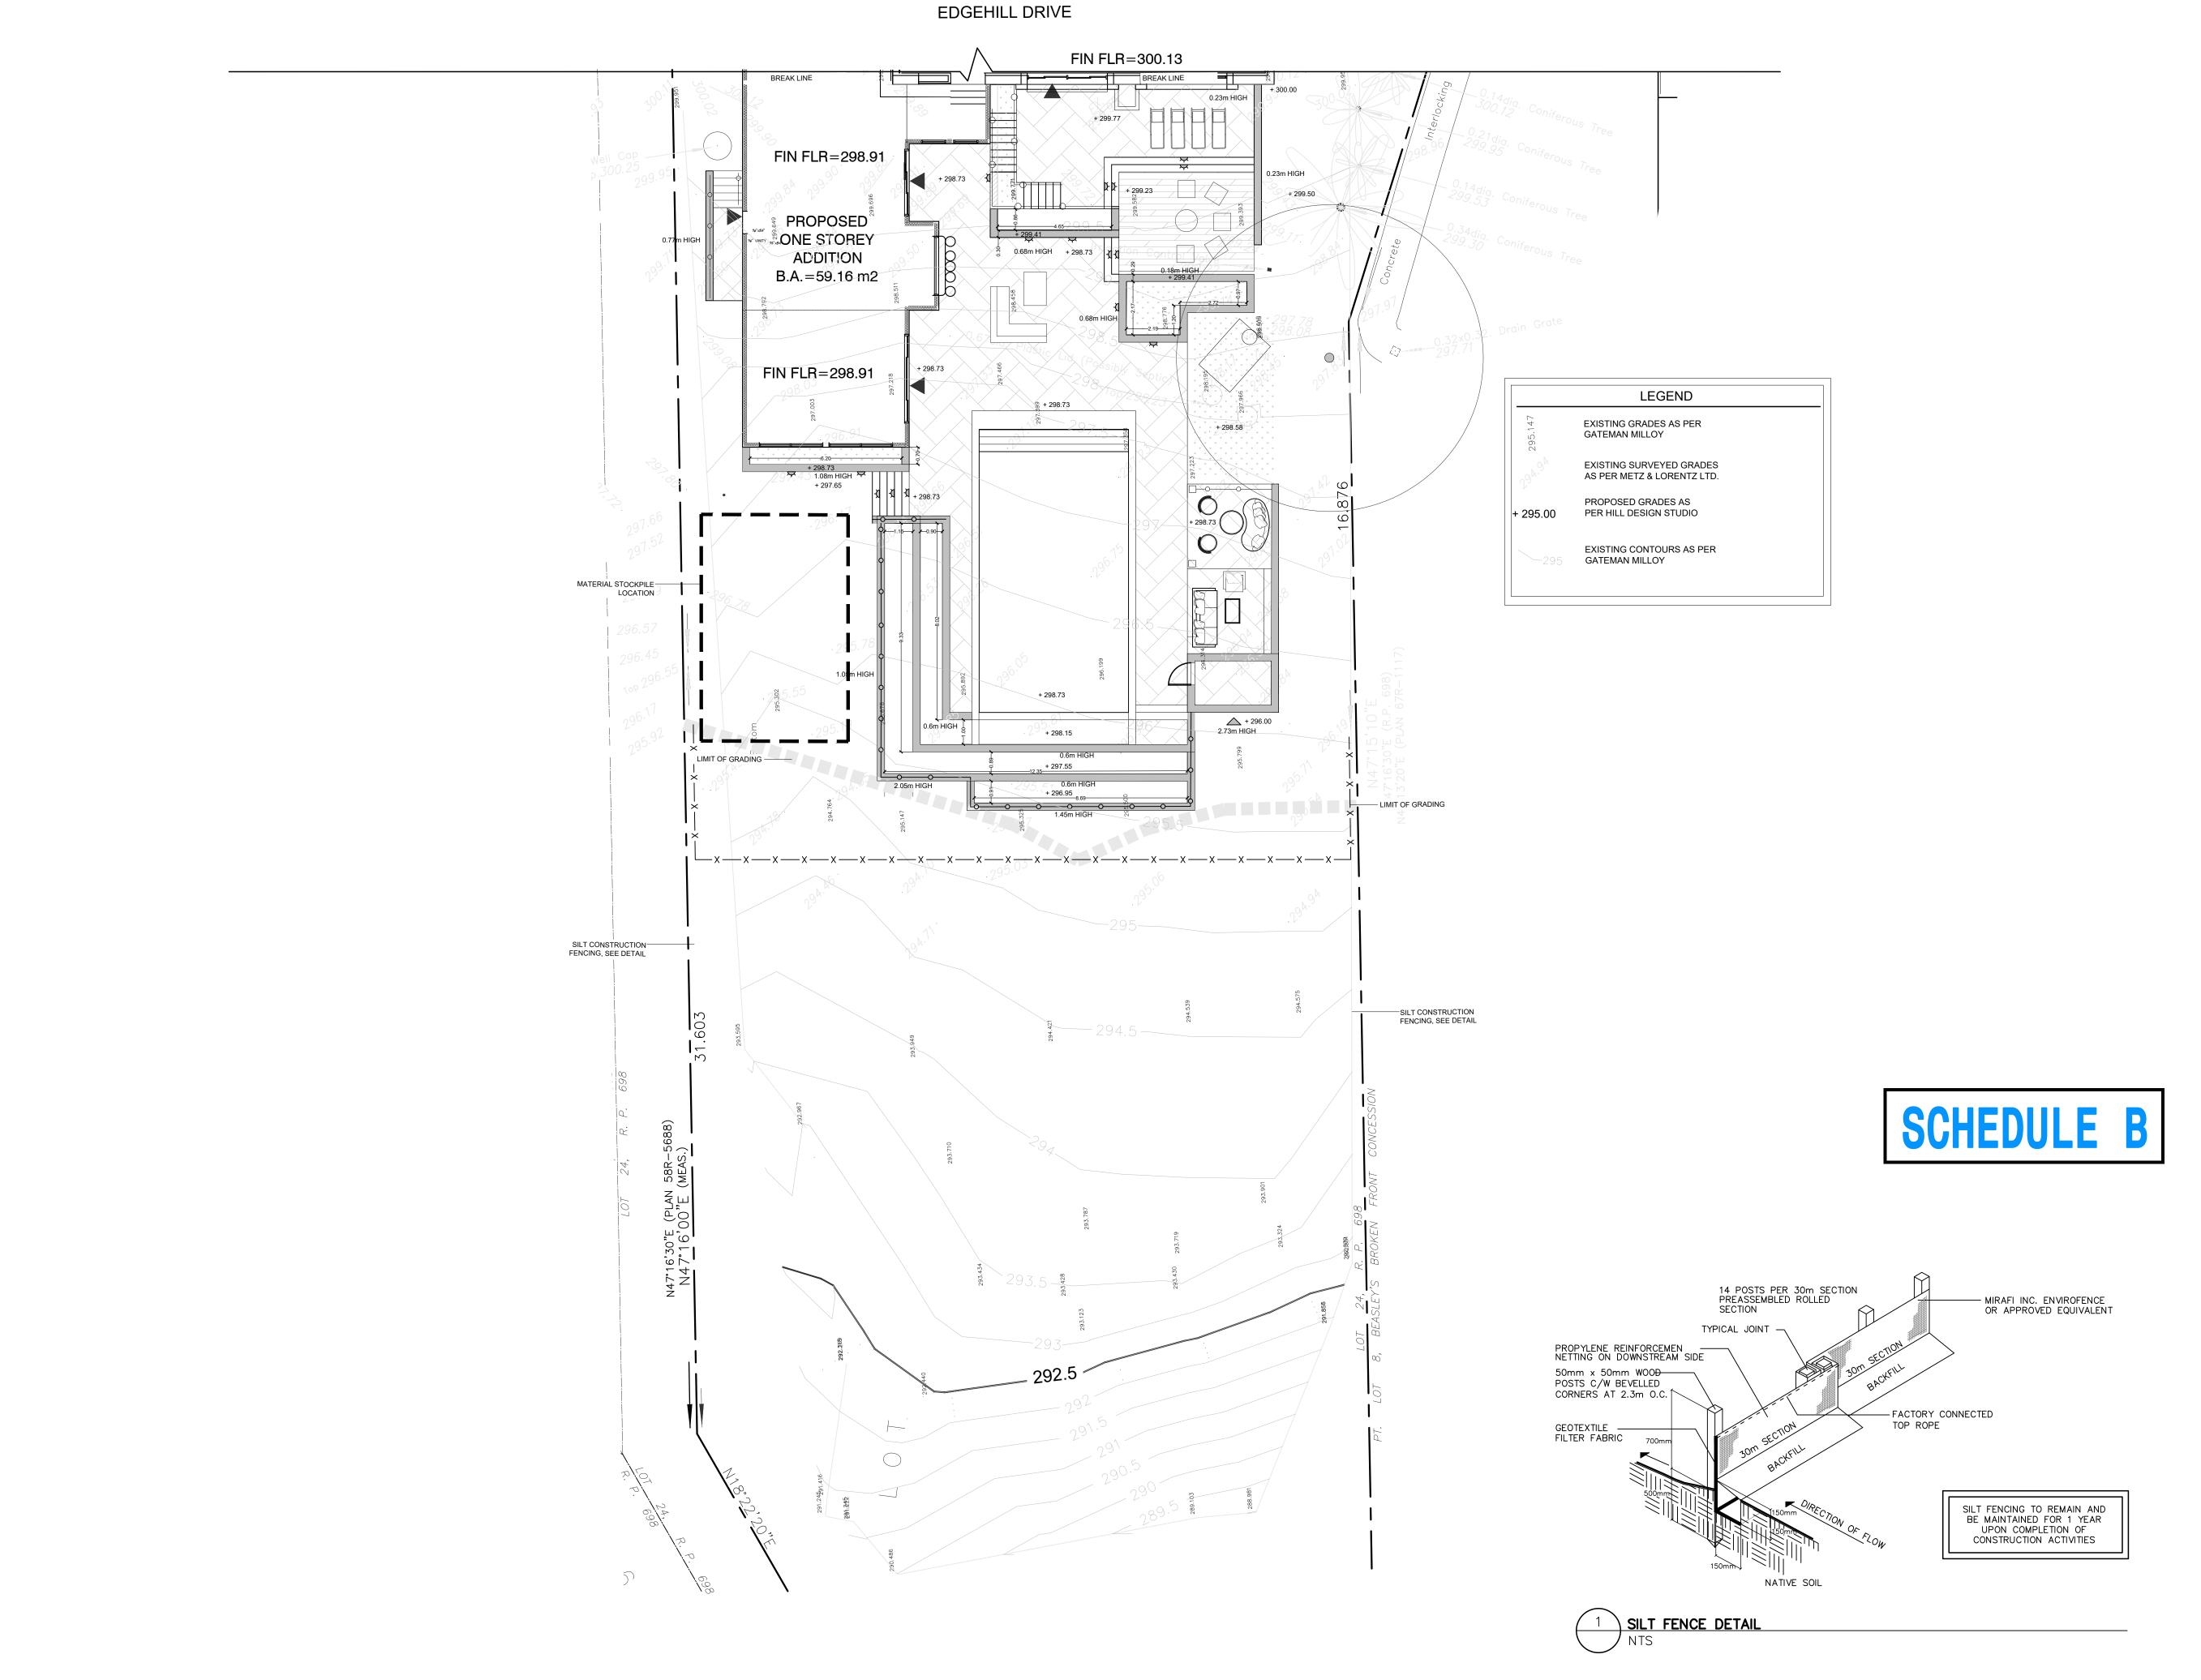



 REVISIONS

 no.
 date
 description
 by


 1.
 JUN.26.24
 Issued for Permit
 AWH

109 Edgehill Drive Kitchener, ON Cober Residence

CONSTRUCTION MANAGEMENT PLAN



PROJECT NO.: 2023-67	DRAWN BY: EA
SCALE: 1:125	DESIGNED BY: AWH
SHEET:	APPROVED BY: AWH
L ₂	PLOT DATE: June 26, 2024

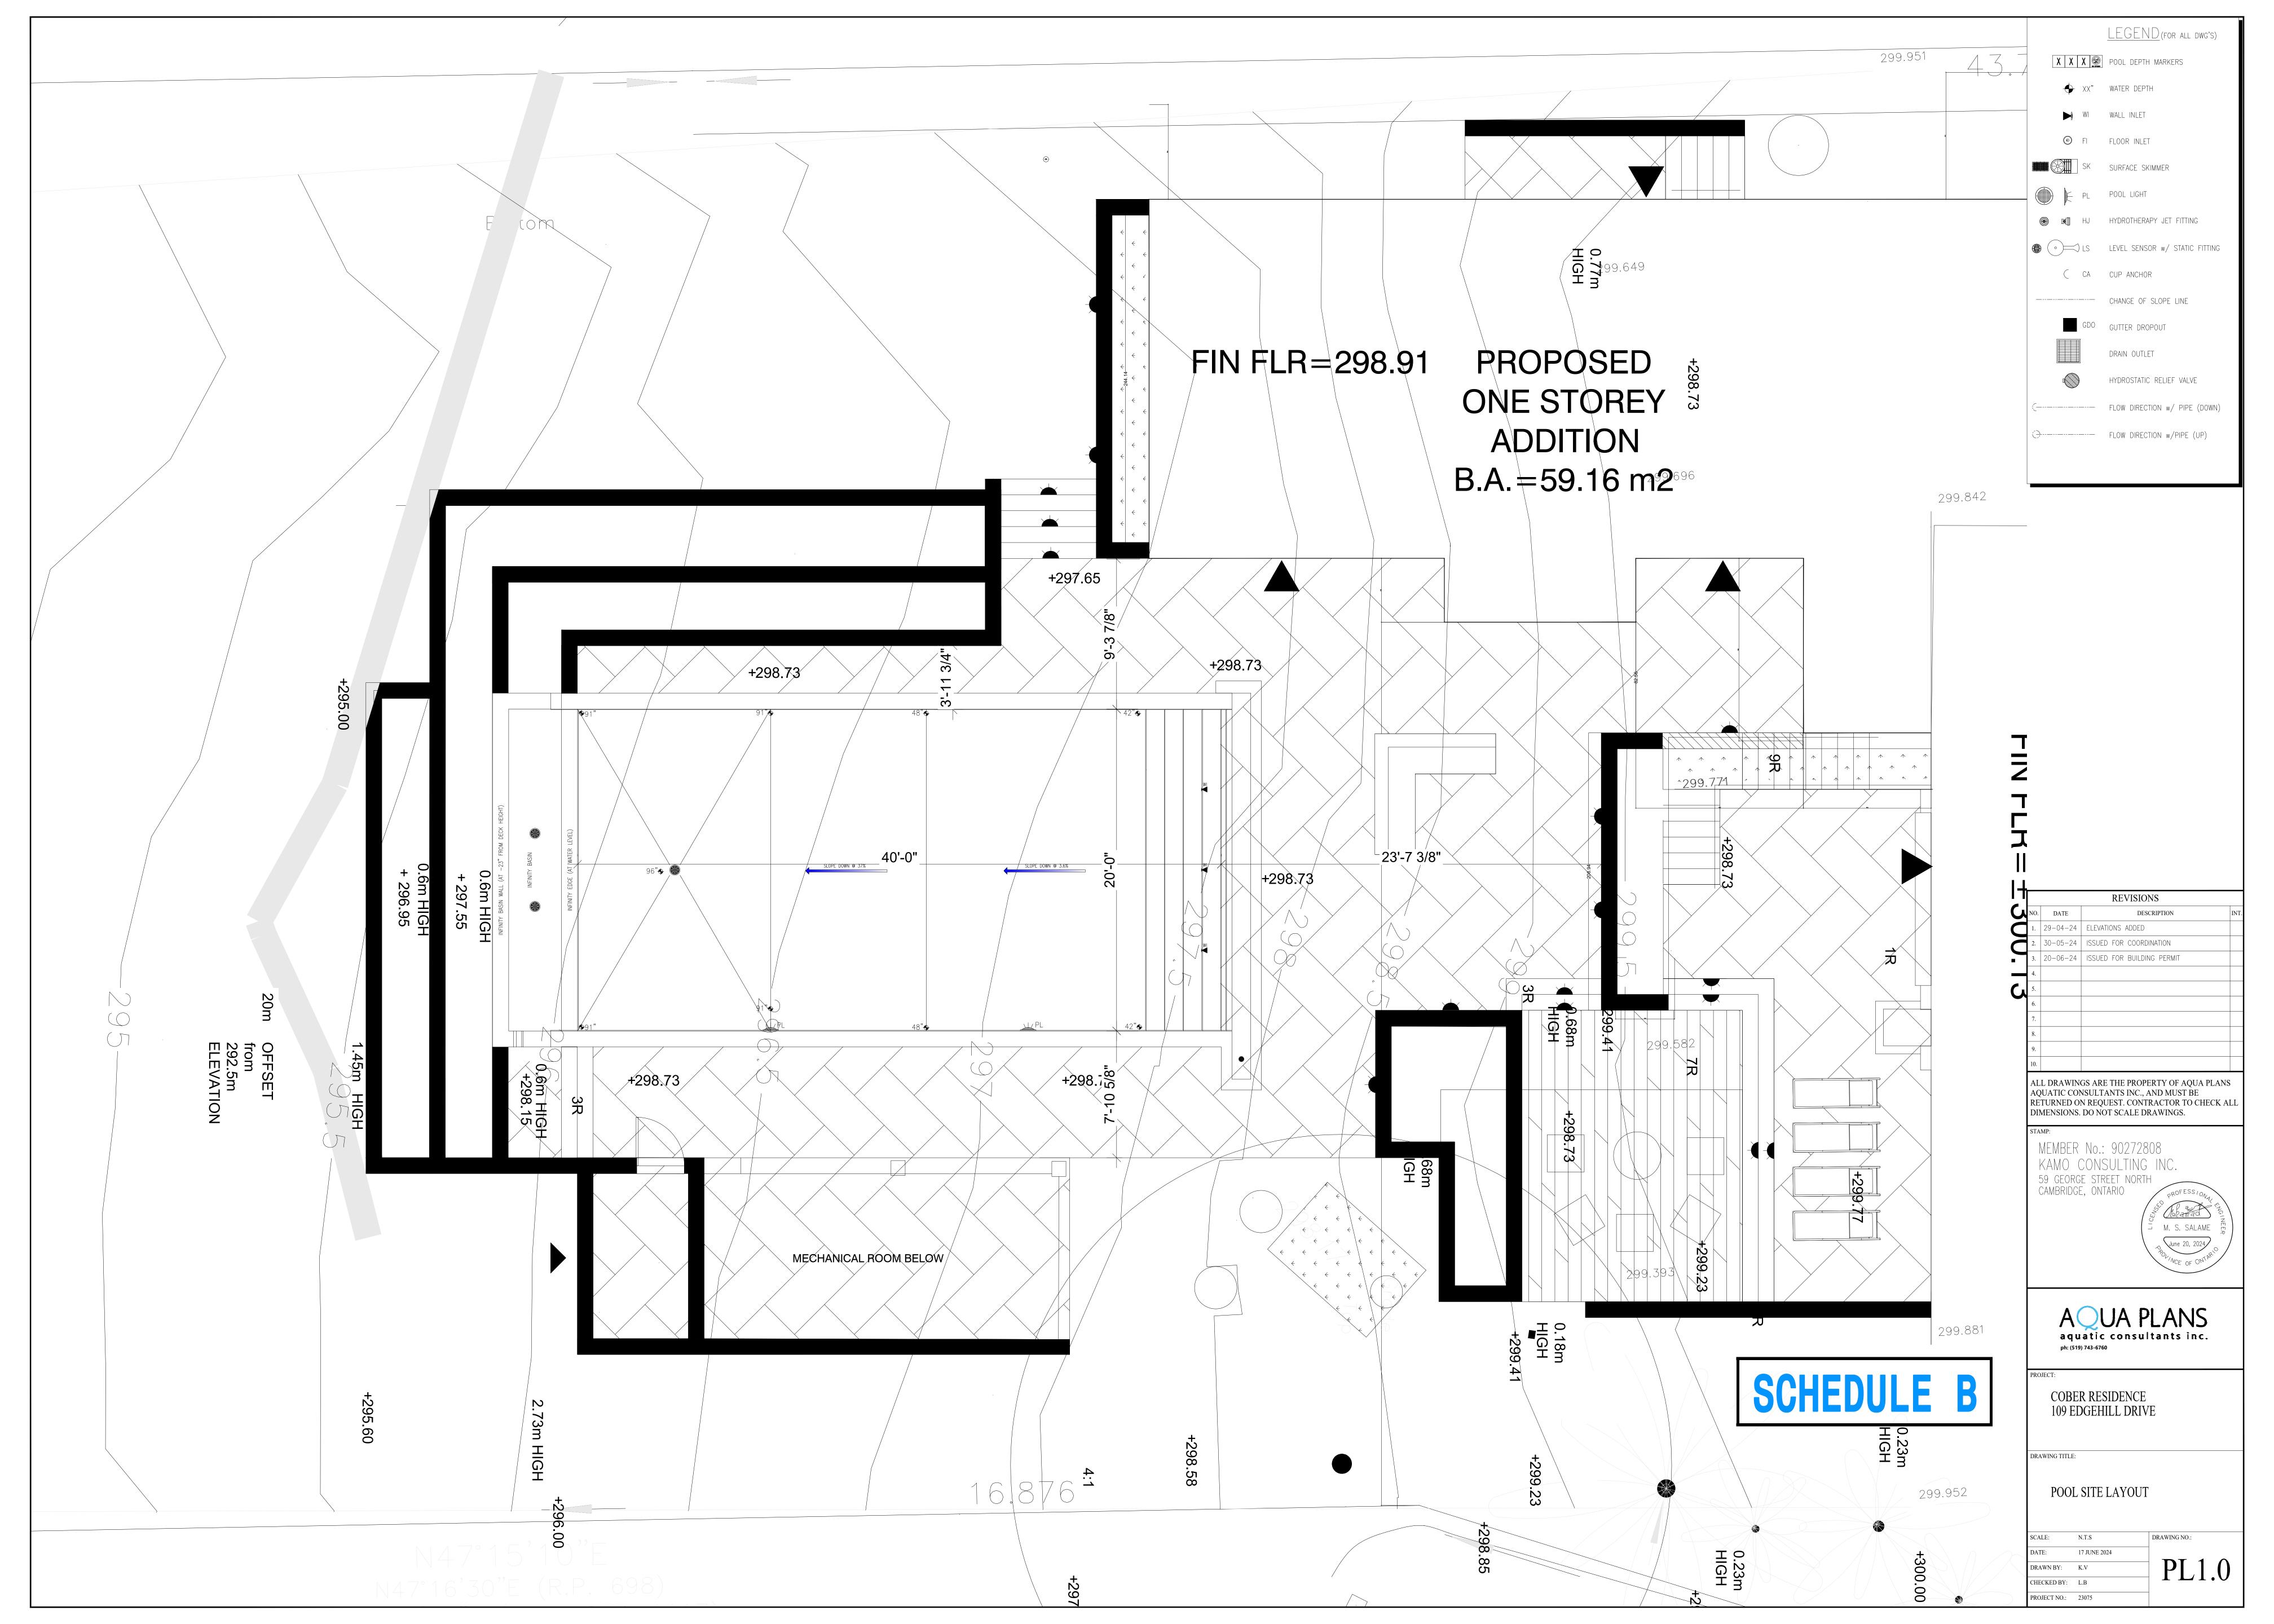

GENERAL NOTES:

- 1. COORDINATE POOL LAYOUT DIMENSIONS WITHIN THE POOL NATATORIUM WITH LATEST ARCHITECTURAL CONSTRUCTION DRAWINGS. IN CASE OF DISCREPANCIES, ARCHITECTURAL DRAWINGS SHALL GOVERN.
- 2. FOR ALL EQUIPMENT, REQUIREMENTS, ACCESSORIES AND ALL MATERIAL ASSEMBLIES, SEE SPECIFICATIONS AND DRAWINGS.
- 3. ALL ASSEMBLIES, LAYOUTS, EQUIPMENT AND MATERIALS SHALL MEET LOCAL, PROVINCIAL, OR PREVAILING CODES, AMENDMENTS AND HEALTH DEPARTMENT REQUIREMENTS (MOST STRINGENT OF SUCH).
- 4. SPC SHALL VERIFY ALL DIMENSIONS, CONDITIONS AND COORDINATE / VERIFY ALL MECHANICAL, ELECTRICAL, STRUCTURAL, EQUIPMENT AND FINISH REQUIREMENTS AS NECESSARY PER CODE AND CONSTRUCTION
- 5. ALL CONDITIONS, CLEARANCES, FINISHES, EQUIPMENT AND ACCESSORIES SHALL COMPLY WITH PREVAILING ACCESSIBILITY REQUIREMENTS IN JURISDICTION.
- 6. SEE SPECIFICATIONS AND ALL DRAWING DETAILS FOR POOL RELATED SCOPE OF WORK LIMITS.
- 7. DRAWINGS AND DETAILS DEFINE LIMITS, SCOPE, DETAILS AND DATA FOR POOLS AND POOL-RELATED EQUIPMENT AND ACCESSORIES ONLY.

WATER STOPS:

1. WATER STOP AT WALL AND FLOOR INTERSECTION SHALL BE 100mm PVC, RIBBED WITH CENTER BULB.

PIPING DESIGN NOTES:

- 1. ALL PIPING TO BE SCHEDULE 40 PVC, NSF APPROVED, ASTM #D1785, UNLESS OTHERWISE NOTED.
- 2. ALL PIPING TO BE RUN IN POOL WALLS WERE POSSIBLE.
- 3. ALL PIPING TO AND FROM HEAT EXCHANGERS SHALL BE CPVC WITHIN 3050mm OF THE EXCHANGER UNIT. (BY OTHERS)
- 4. ALL VISIBLE PIPING MUST BE LABELED WITH DIRECTIONAL ARROWS & TYPE OF WATER IT CARRIES (i.e. SKIMMERS, MAIN DRAINS, ETC.) IDENTIFICATION AT 3048mm MAXIMUM O.C. INTERVALS.
- CHLORINE (LIQUID OR GAS) YELLOW
- POTABLE WATER GREEN (AS PER ONTARIO REGULATION - P.R.O. 1990, REG. 565. S. 6(4)
- 5. PRESSURE PIPING:

6. GRAVITY PIPING:

- MAX. 2.3 m/s (7.5 FPS)
- 5. SUCTION PIPING: • MAX. 1.50 m/s (5 FPS)
- MAX. 0.9 m/s (3 FPS) 7. DRAIN AND SUCTION GRATES FREE OPEN AREAS TO PROVIDE FLOW VELOCITIES NOT TO EXCEED 0.45 m/s (1

1/2 FPS). ALL DRAIN GRATES SHALL BE SIZED FOR FULL PUMP FLOW.

8. STRUCTURAL SUPPORT FOR PIPING AS SPECIFIED BY MANUFACTURER. REFER TO DETAIL SHEETS.

ELECTRICAL NOTES: (ALL ELECTRICAL IS BY OTHERS)

- 1. PRIMARY GROUNDING LOOP MUST BE PROVIDED BY CERTIFIED ELECTRICAL CONTRACTOR.
- 2. ALL REINFORCING BAR IN POOL STRUCTURE MUST BE BONDED TO PRIMARY GROUNDING LOOP BY CERTIFIED ELECTRICAL CONTRACTOR.
- 3. ALL METAL POOL FITTINGS AND ACCESSORIES WITHIN 1524mm OF POOL WATER MUST BE BONDED TO PRIMARY GROUNDING LOOP.
- 4. ALL PUMPS SHALL BE WIRED BY CERTIFIED ELECTRICAL CONTRACTOR.
- 5. GROUNDING OF CONCRETE REINFORCEMENT BY CERTIFIED ELECTRICAL CONTRACTOR.

WEEPING TILES:

- 1. SPC TO PROVIDE AND INSTALL COMPLETE WEEPING TILE SYSTEM AS SHOWN ON THE POOL DRAWINGS.
- 2. MECHANICAL CONTRACTOR TO COORDINATE PIPE LOCATION ON SITE. OFFSET AND/OR REVISE INVERT ELEVATION TO SUIT IF REQUIRED.
- 3. CONTINUATION OF 100mmø SOLID PIPE TO STORM SYSTEM BY PLUMBING CONTRACTOR. SUPPLY AND INSTALLATION OF 100mmø SOLID PIPE BY PLUMBING CONTRACTOR.
- 4. MAIN WEEPING TILE SUMP PIT SUPPLY AND INSTALLATION OR DRAIN TO LOWER GROUND
- <u>REINFORCEMENT:</u>
- EXTENSIONS. LENGTHS GIVEN FOR BENT BARS DO NOT INCLUDE THE RADIUS AND MINIMUM EXTENSION FOR

1. HOOKS AND BENDS SHALL CONFORM TO CAN/CSA A23.4 STANDARDS FOR MINIMUM BEND RADIUS AND

- 2. BARS SHALL BE LAPPED 36 BAR DIAMETERS AT SPLICES UNLESS DETAILED OTHERWISE. NO SPLICES SHALL BE PERMITTED IN SQUARE FOOTINGS.
- 3. PROVIDE CORNER BARS AT ALL INTERSECTIONS OF BEAMS AND WALLS PER 'TYPICAL DETAILS'
- 4. COVER REQUIREMENTS FOR REINFORCING:
- A)POOL SLABS: 75mm RE: DETAILS B)POOL WALLS: 75mm RE: DETAILS
- 5. REINFORCING IN SLABS ON GRADE SHALL BE PLACED AT THE CENTER OF THE SLAB, UNLESS NOTED OTHERWISE.

CAST-IN-PLACE CONCRETE

- 1. ALL CONCRETE WORK SHALL BE IN ACCORDANCE WITH THE REQUIREMENTS OF THE CAN/CSA A23.1 CONCRETE MATERIALS AND METHODS OF CONCRETE CONSTRUCTION.
- CONCRETE MIX SCHEDULE PORTLAND CEMENT: ASTM C150, TYPE F-1.
- PLASTICIZING ADMIXTURE: ASTM C494, TYPE A. WATER TO CEMENT RATIO: 0.50
- 275Kg CEMENT WITH A MAXIMUM OF 65Kg OF FLY ASH
- 2. STRENGTH LISTED SHALL BE MINIMUM DESIGN STRENGTH AT TWENTY EIGHT (28) DAYS OF 30 MPa.
- 3. FIVE TO EIGHT PERCENT (5-8%) AIR ENTRAINMENT SHALL BE ADDED TO CONCRETE MIXES FOR STRUCTURAL
- ELEMENTS PERMANENTLY EXPOSED TO WEATHER. 4. CALCIUM CHLORIDE SHALL NOT BE ADDED TO CONCRETE MIXTURES WITHOUT WRITTEN APPROVAL.
- 5. DO NOT ADD WATER ON SITE.
- 6. MAX SLUMP 75mm BEFORE ADDITION OF MICROFIBERS. MICROFIBERS TO BE PLANT ADDED.
- 7. ALL CONCRETE TO BE CONTINUOUSLY WET CURED FOR 14 DAYS

POOL STRUCTURAL NOTES:

<u>GRANULAR BASE:</u>

1. ALL POOLS ARE DESIGNED TO WITHSTAND ANTICIPATED HYDRAULIC STRUCTURAL LOADING FOR BOTH FULL, AND EMPTY CONDITIONS.


1. SITE PREPARATION AND GRANULAR BASE UNDER POOL SLABS SHALL BE A MINIMUM 150mm THICK LAYER OF OPSS 1010 GRANULAR A MATERIAL COMPACTED TO 100% SPDD, UNLESS OTHERWISE STATED IN GEOTECHNICAL REPORT.


FOUNDATION DESIGN: 1. REFERENCE THE GEOTECHNICAL REPORT FOR SUB GRADE IMPROVEMENT, ENGINEERED BACKFILL GRANULAR MATERIALS SHOULD BE


- PLACED IN THICKNESS AND COMPACTED AS PER SOIL REPORT.
- 2. SOIL BEARING SHALL BE MIN. 95.76 KPa PRIOR TO NEW SOIL REPLACEMENT.
- 3. EXCAVATION MATERIAL CAN BE USED FOR BACKFILLING IF APPROVED BY GEOTECHNICAL ENGINEER. ALL SPOILS TO BE STOCK PILED ON SITE FOR USE AS DIRECTED BY OWNER.
- 4. ALL SOIL, CONCRETE, AND ANY OTHER TESTING WILL BE DONE AT OWNERS EXPENSE.
- 5. PROVIDE HYDROSTATIC RELIEF VALVES IN EVERY MAIN DRAIN SUMP AT THE BOTTOM OF POOLS TO RELIEVE HYDROSTATIC PRESSURE.
- 6. CONTRACTOR SHALL VERIFY THAT EXISTING BUILDING FOUNDATIONS WILL NOT BE UNDERMINED BY THE PROPOSED EXCAVATION. A MINIMUM SLOPE OF 1:1 FROM THE BOTTOM OF EXISTING FOOTING SHALL NOT BE UNDERMINED. SHOULD EXCAVATION INFRINGE UPON THIS AREA, THE CONTRACTOR SHALL BE RESPONSIBLE FOR DESIGN OF SHORING. A LICENSED STRUCTURAL ENGINEER HAVING JURISDICTION IN THE PROVINCE/STATE WHERE PROJECT IS LOCATED, SHALL BE RETAINED FOR THIS PURPOSE BY THE CONTRACTOR.)

1. ALL CONSTRUCTION SHALL BE IN ACCORDANCE WITH THE LATEST ISSUES AND AMENDMENTS OF THE


- PROVINCIAL BUILDING CODE PROVINCIAL BUILDING CODE ACT
- OCCUPATIONAL HEALTH AND SAFETY ACT.
- PROVINCIAL PLUMBING CODE - ELECTRICAL SAFETY AUTHORITY
- LOCAL BUILDING REGULATIONS AND BY—LAWS
- 2. REQUIREMENTS FOR CONCRETE TO COMPLY WITH CSA A23.3 DESIGN OF CONCRETE STRUCTURES.
- 3. CONCRETE AND REINFORCING STEEL: CAN/CSA A23.4 PRE-CAST CONCRETE MATERIALS AND CONSTRUCTION.
- 4. WHERE CONFLICTS OCCUR BETWEEN THE BUILDING CODE AND MATERIAL CODES, THE BUILDING CODE SHALL GOVERN.

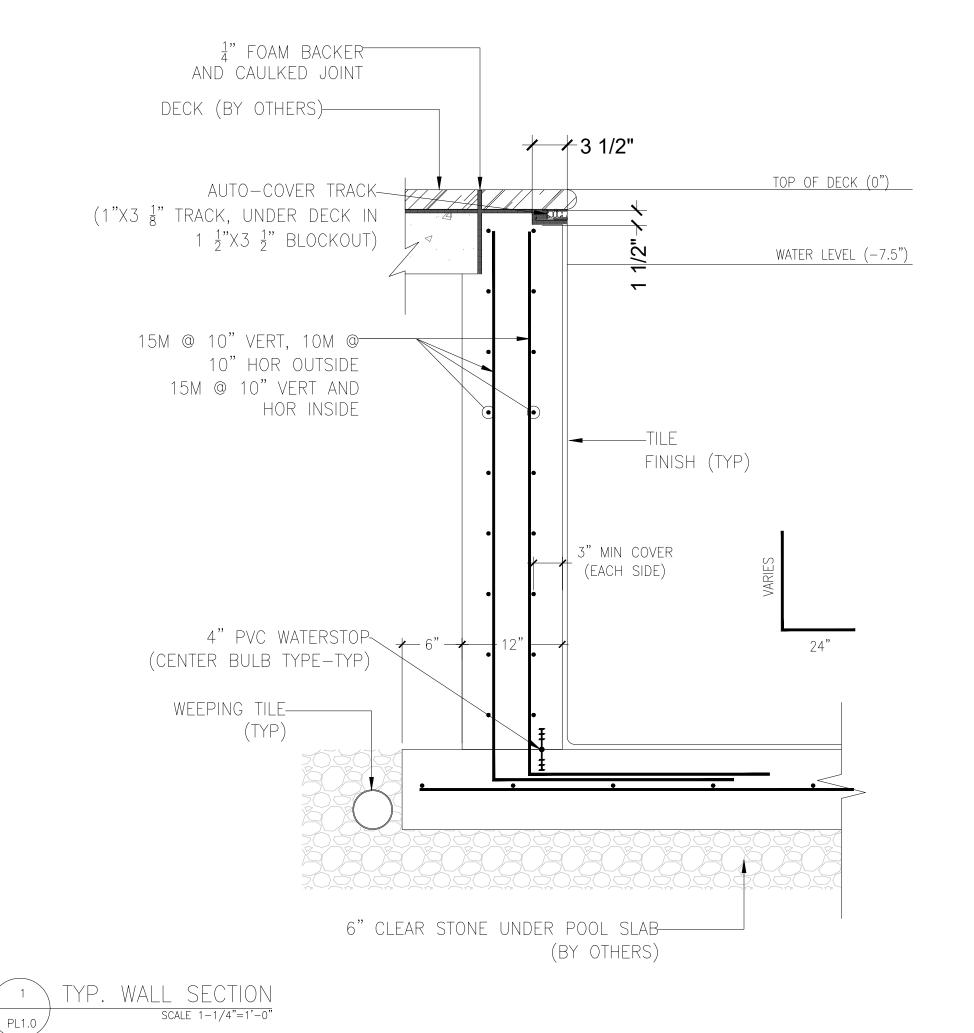


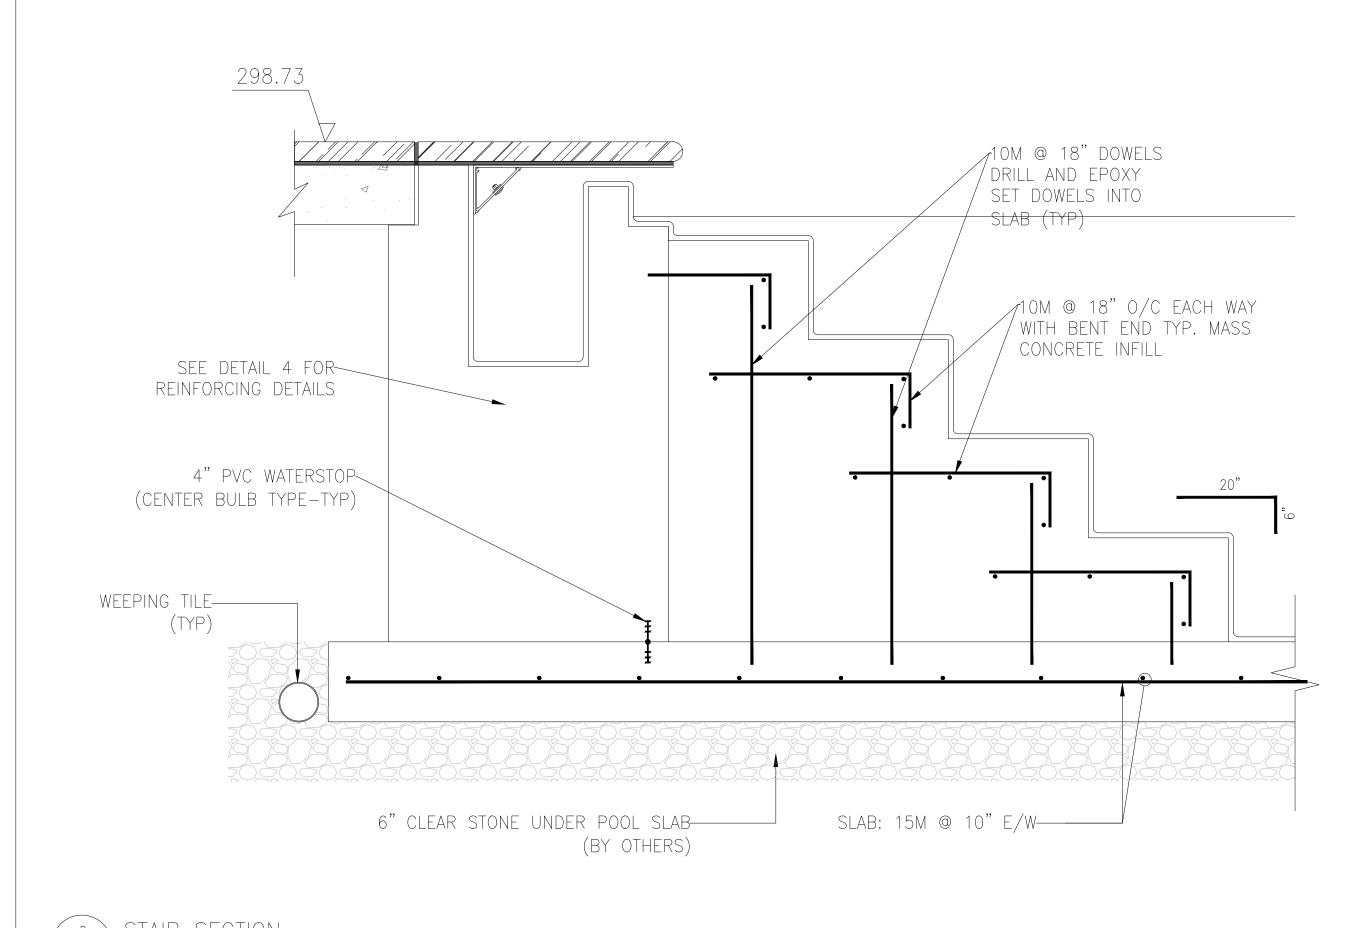


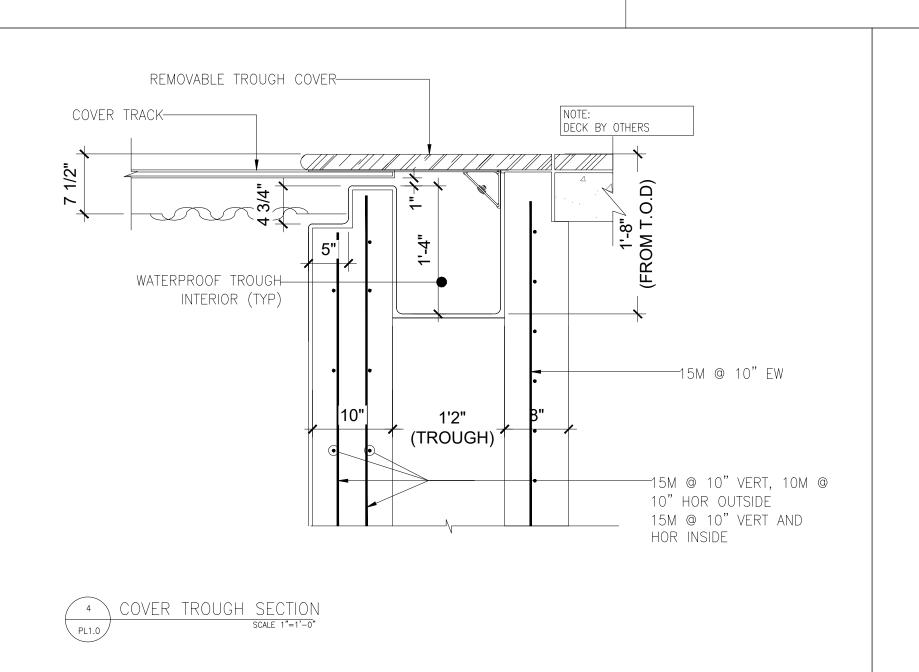


SCALE 1-1/4"=1'-0'

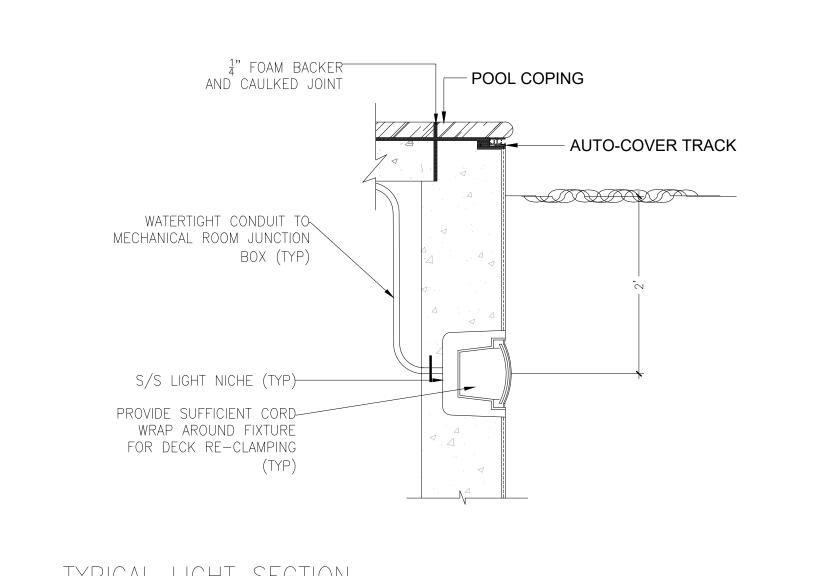


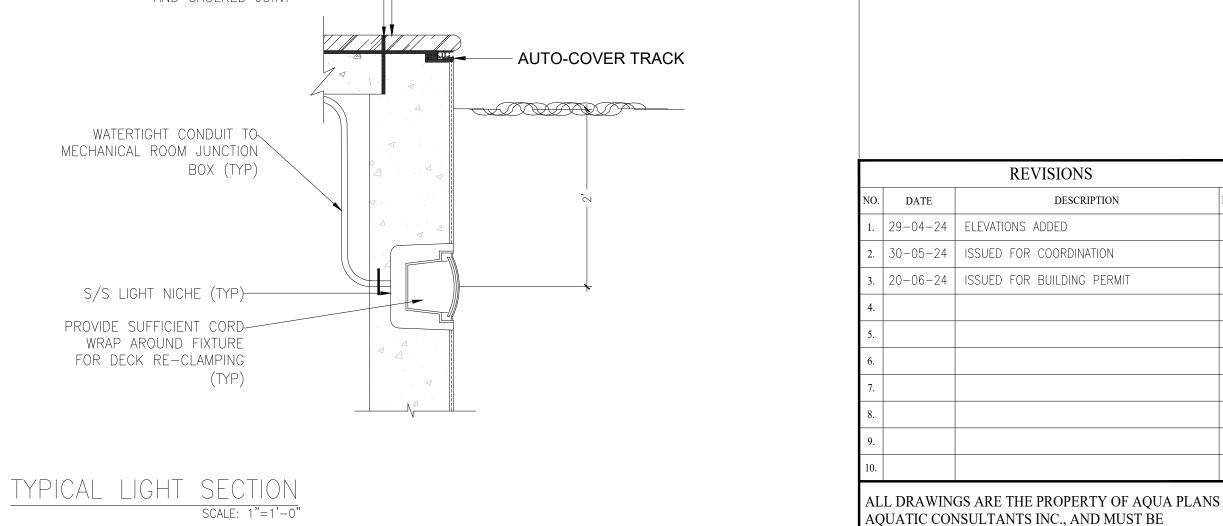


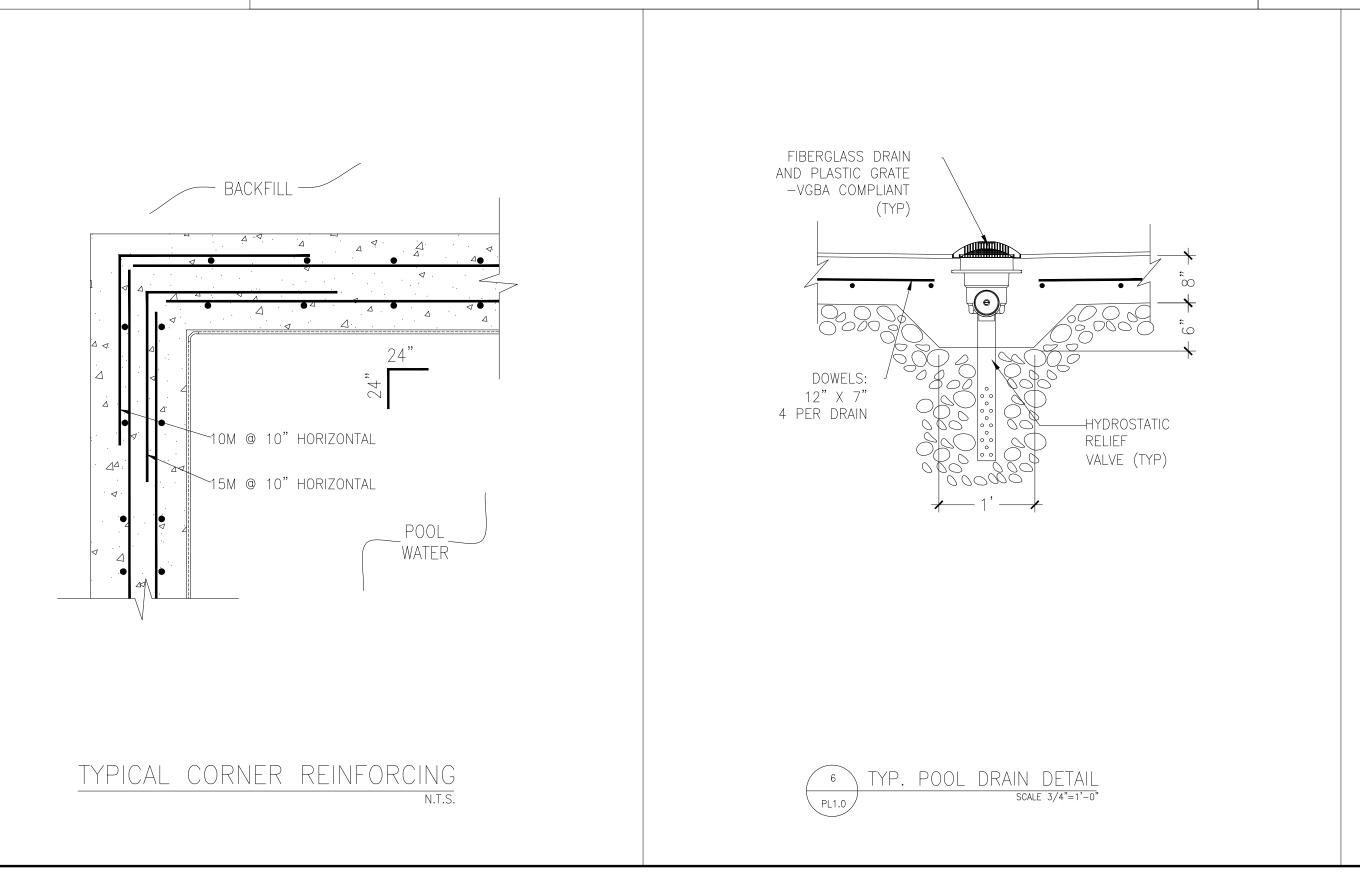


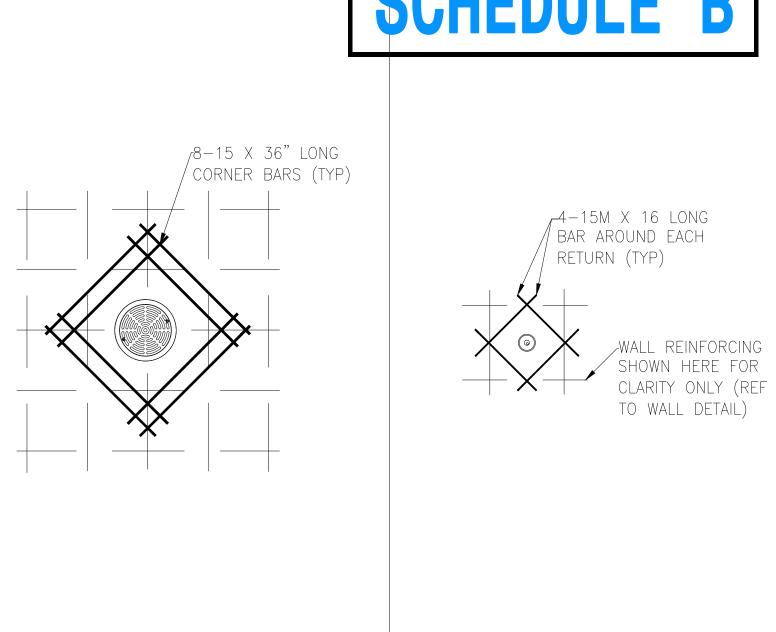

POOL MAIN DRAIN REINFORCING

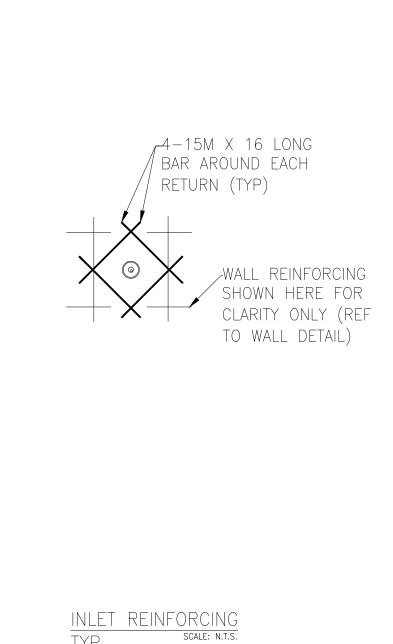

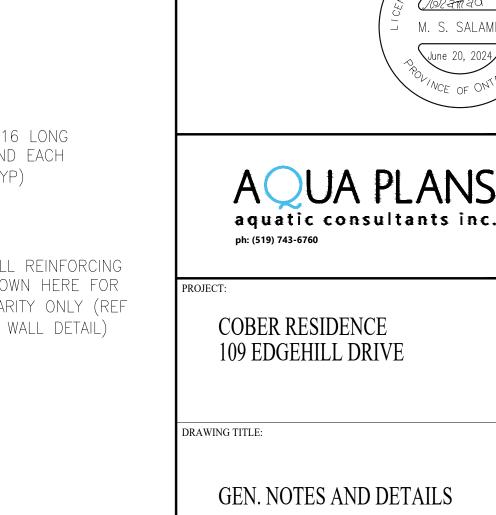

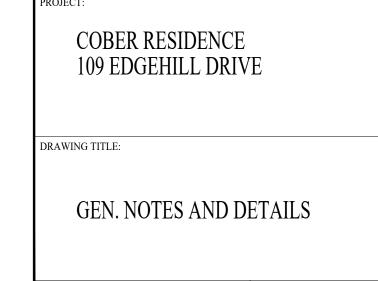

REVISIONS

RETURNED ON REQUEST. CONTRACTOR TO CHECK ALL

M. S. SALAME

June 20, 2024


DIMENSIONS. DO NOT SCALE DRAWINGS.


59 GEORGE STREET NORTH

CAMBRIDGE, ONTARIO

DESCRIPTION

DRAWING NO.: DRAWN BY: K.V CHECKED BY: L.B PROJECT NO.: 23075

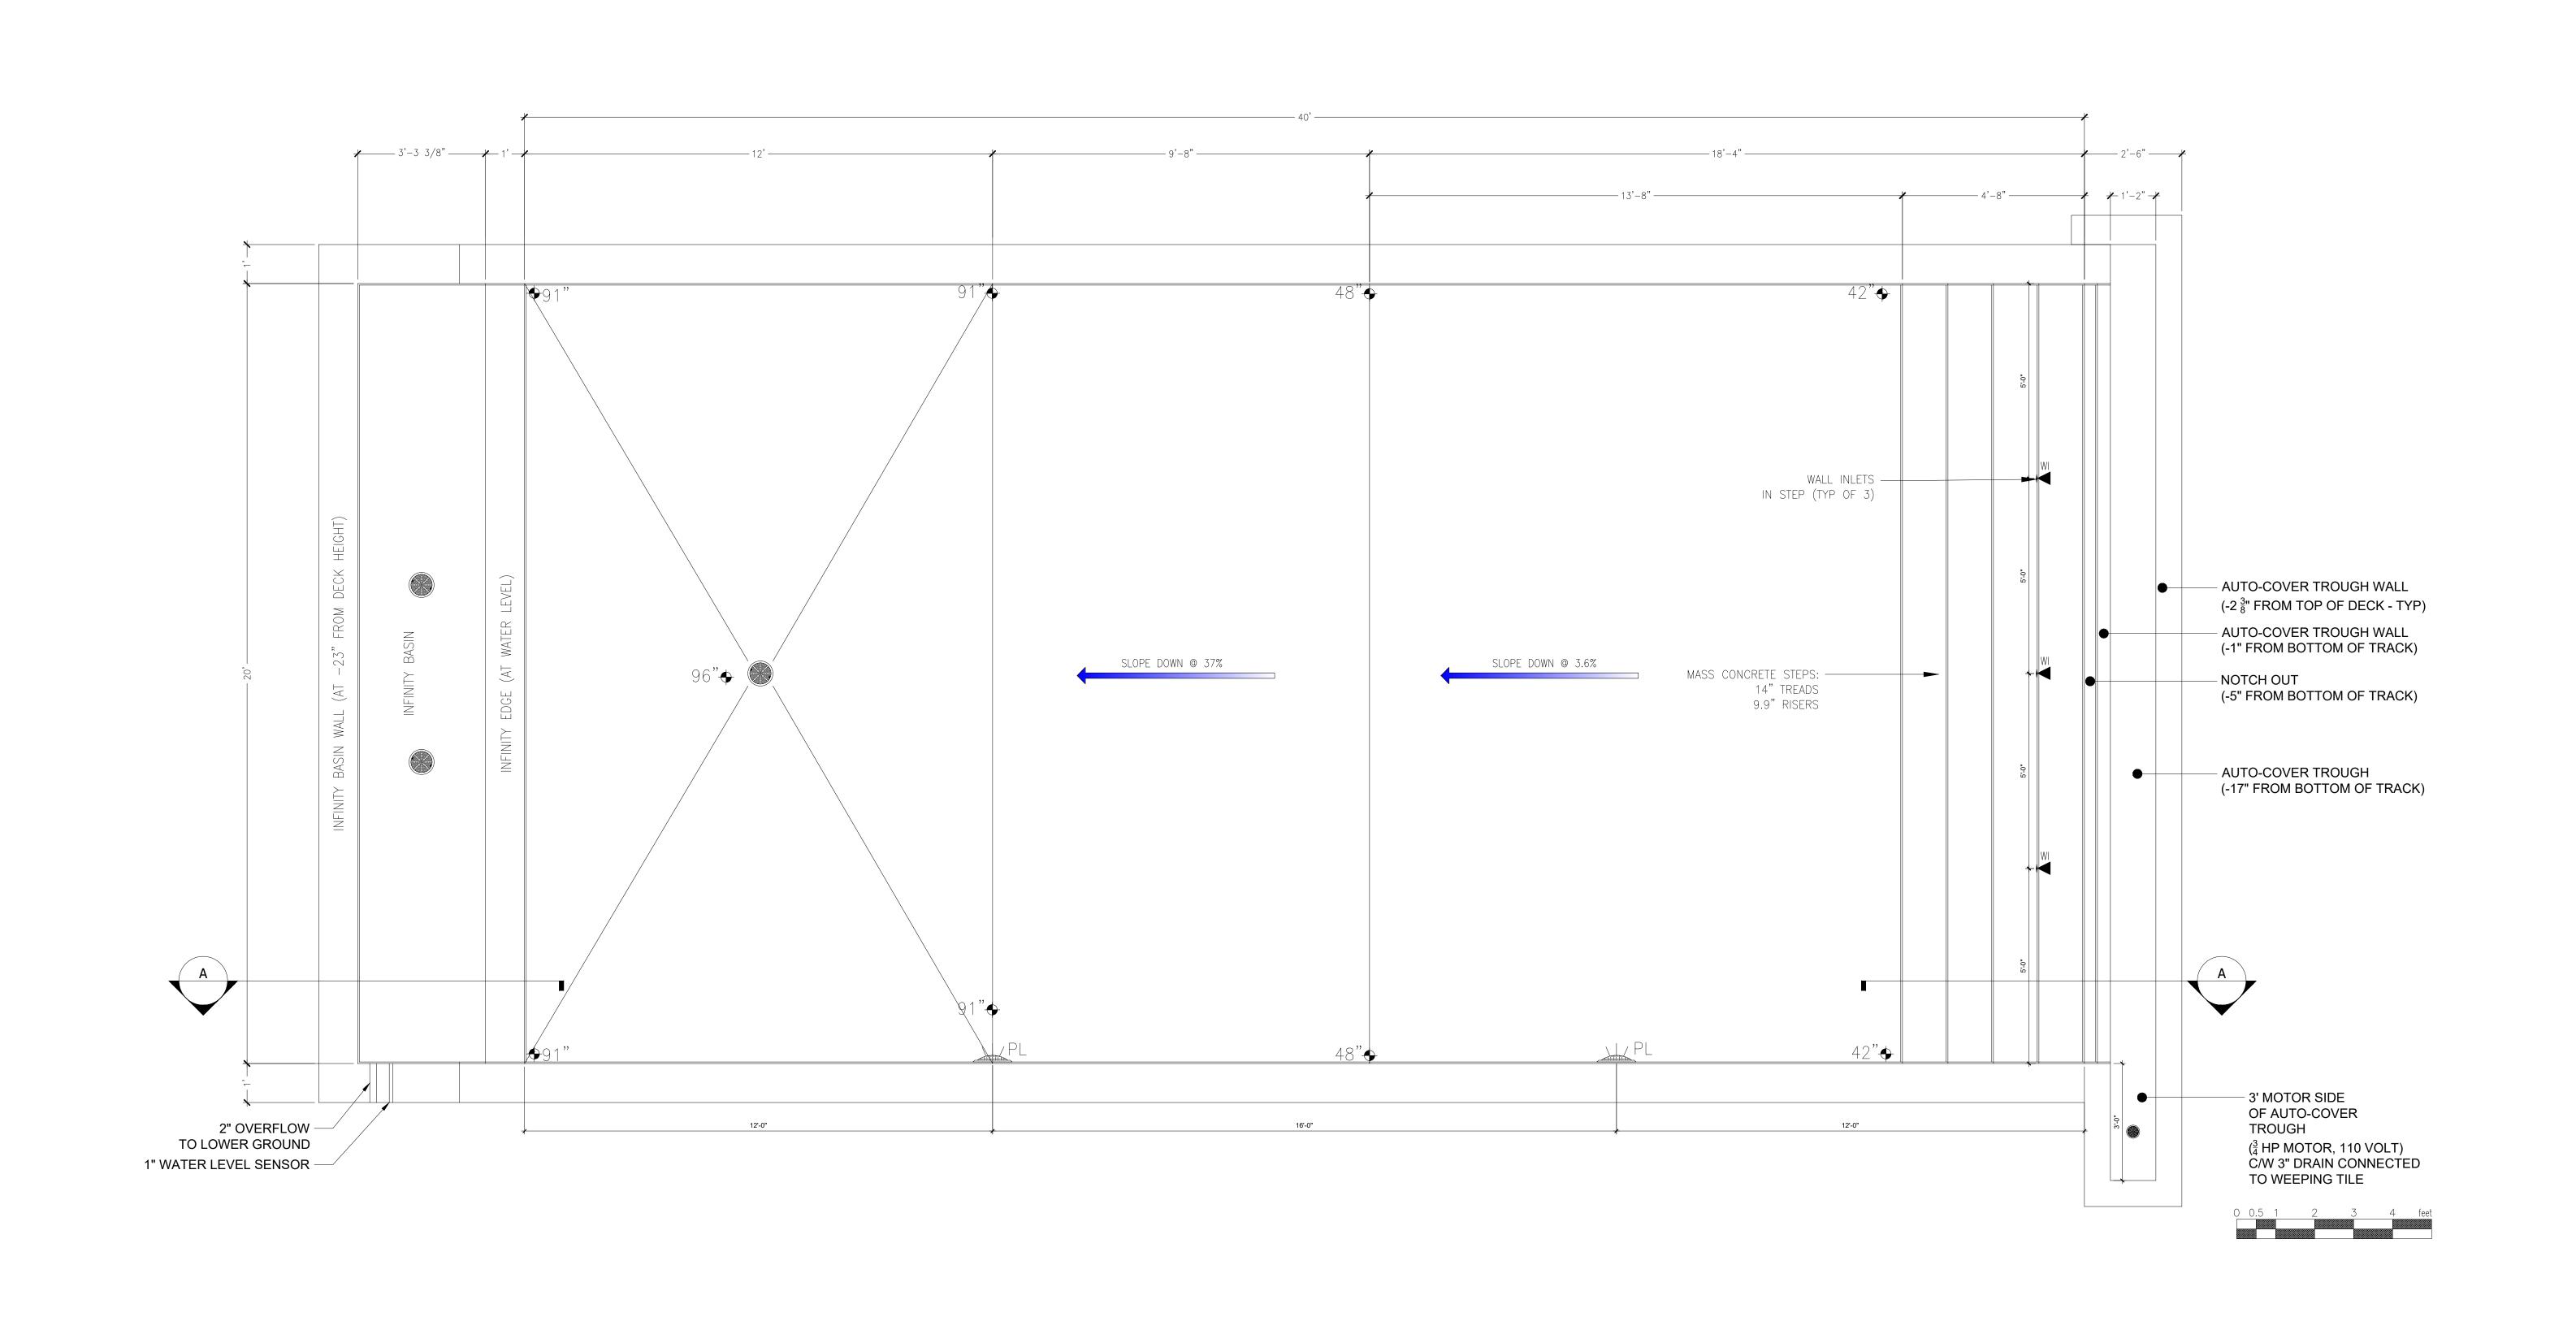

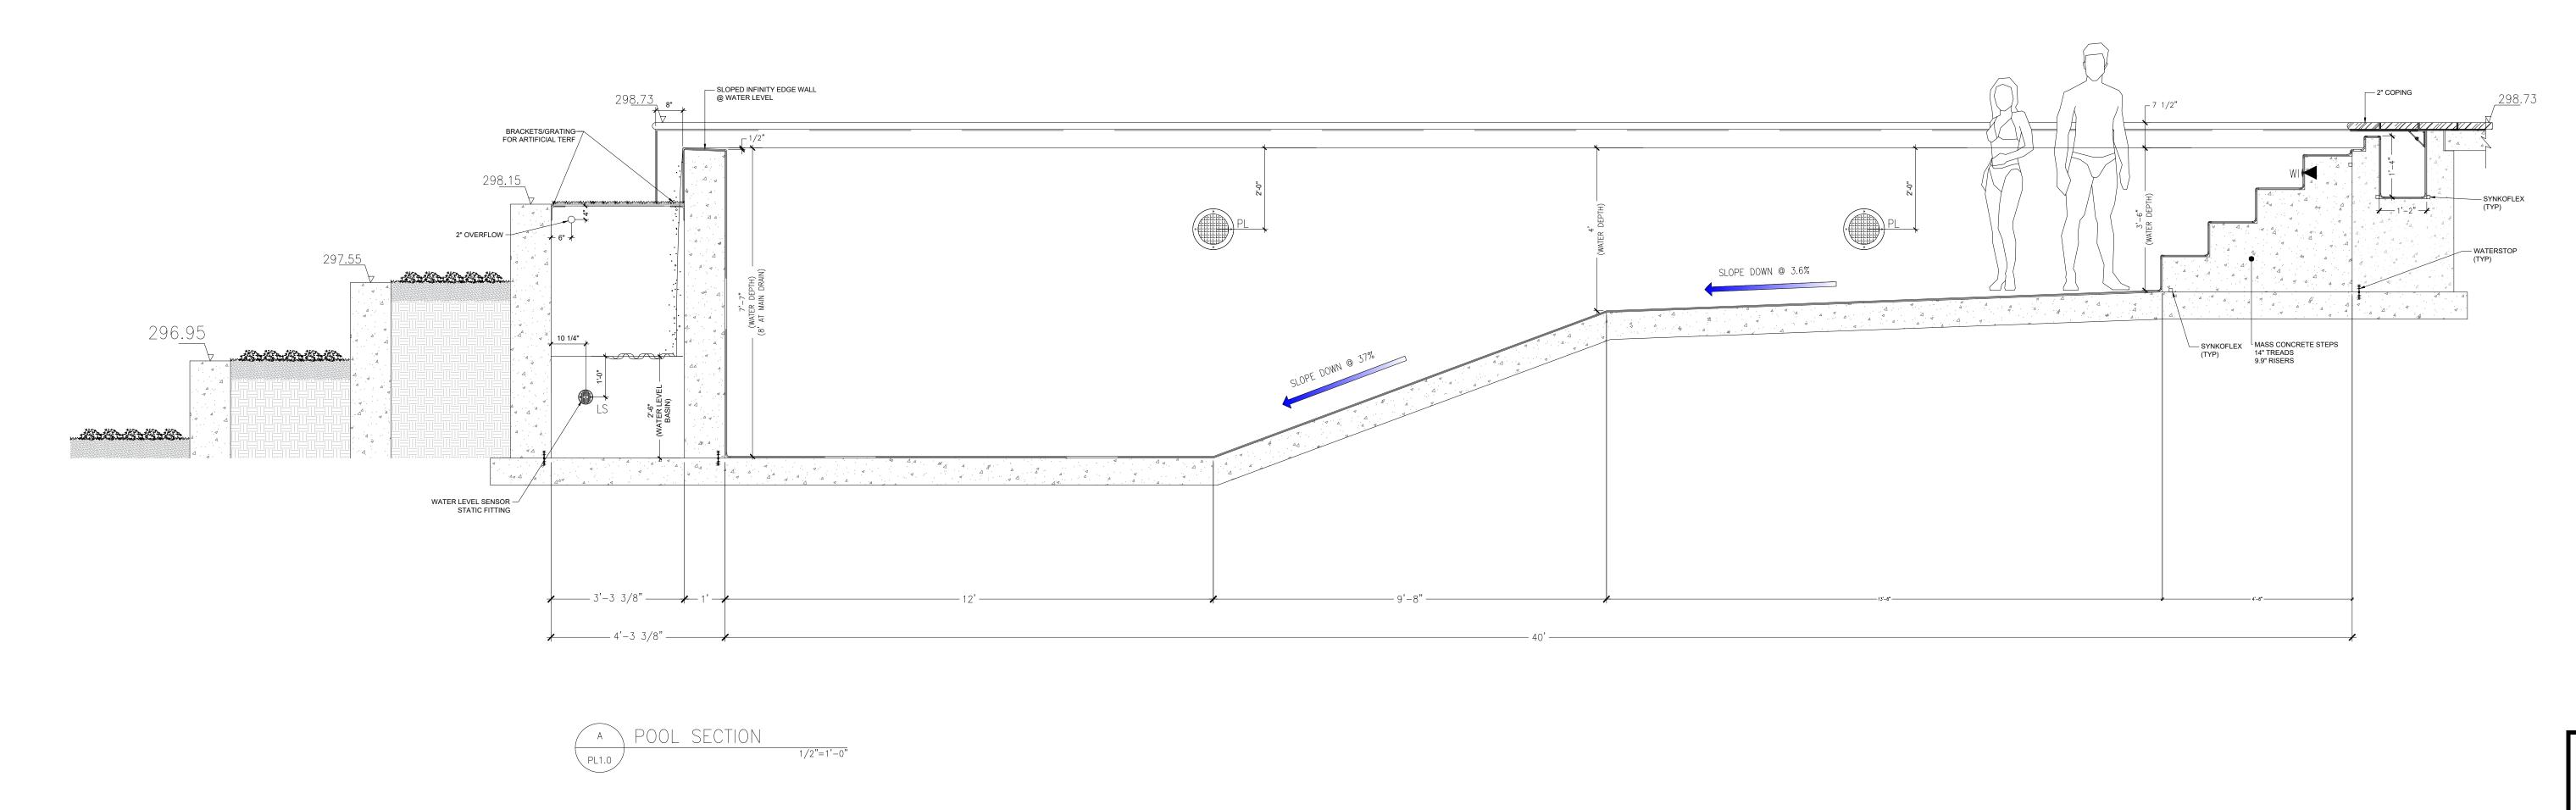

<u>LEGEND</u>(for all dwg's) X X X POOL DEPTH MARKERS ♦ XX" WATER DEPTH WI WALL INLET FI FLOOR INLET SK SURFACE SKIMMER PL POOL LIGHT LS LEVEL SENSOR w/ STATIC FITTING CA CUP ANCHOR GDO GUTTER DROPOUT DRAIN OUTLET HYDROSTATIC RELIEF VALVE (----- FLOW DIRECTION w/ PIPE (DOWN) FLOW DIRECTION w/PIPE (UP)

		REVISIONS	
NO.	DATE	DESCRIPTION	INT
1.	29-04-24	ELEVATIONS ADDED	
2.	30-05-24	ISSUED FOR COORDINATION	
3.	20-06-24	ISSUED FOR BUILDING PERMIT	
4.			
5.			
6.			
7.			
8.			
9.			
10.			

ALL DRAWINGS ARE THE PROPERTY OF AQUA PLANS AQUATIC CONSULTANTS INC., AND MUST BE RETURNED ON REQUEST. CONTRACTOR TO CHECK ALL DIMENSIONS. DO NOT SCALE DRAWINGS.

59 GEORGE STREET NORTH CAMBRIDGE, ONTARIO

AQUA PLANS aquatic consultants inc.

M. S. SALAME

COBER RESIDENCE 109 EDGEHILL DRIVE


ph: (519) 743-6760


DRAWING TITLE:


POOL PLAN AND SECTION

DRAWING NO.: DRAWN BY: K.V CHECKED BY: L.B


PROJECT NO.: 23075

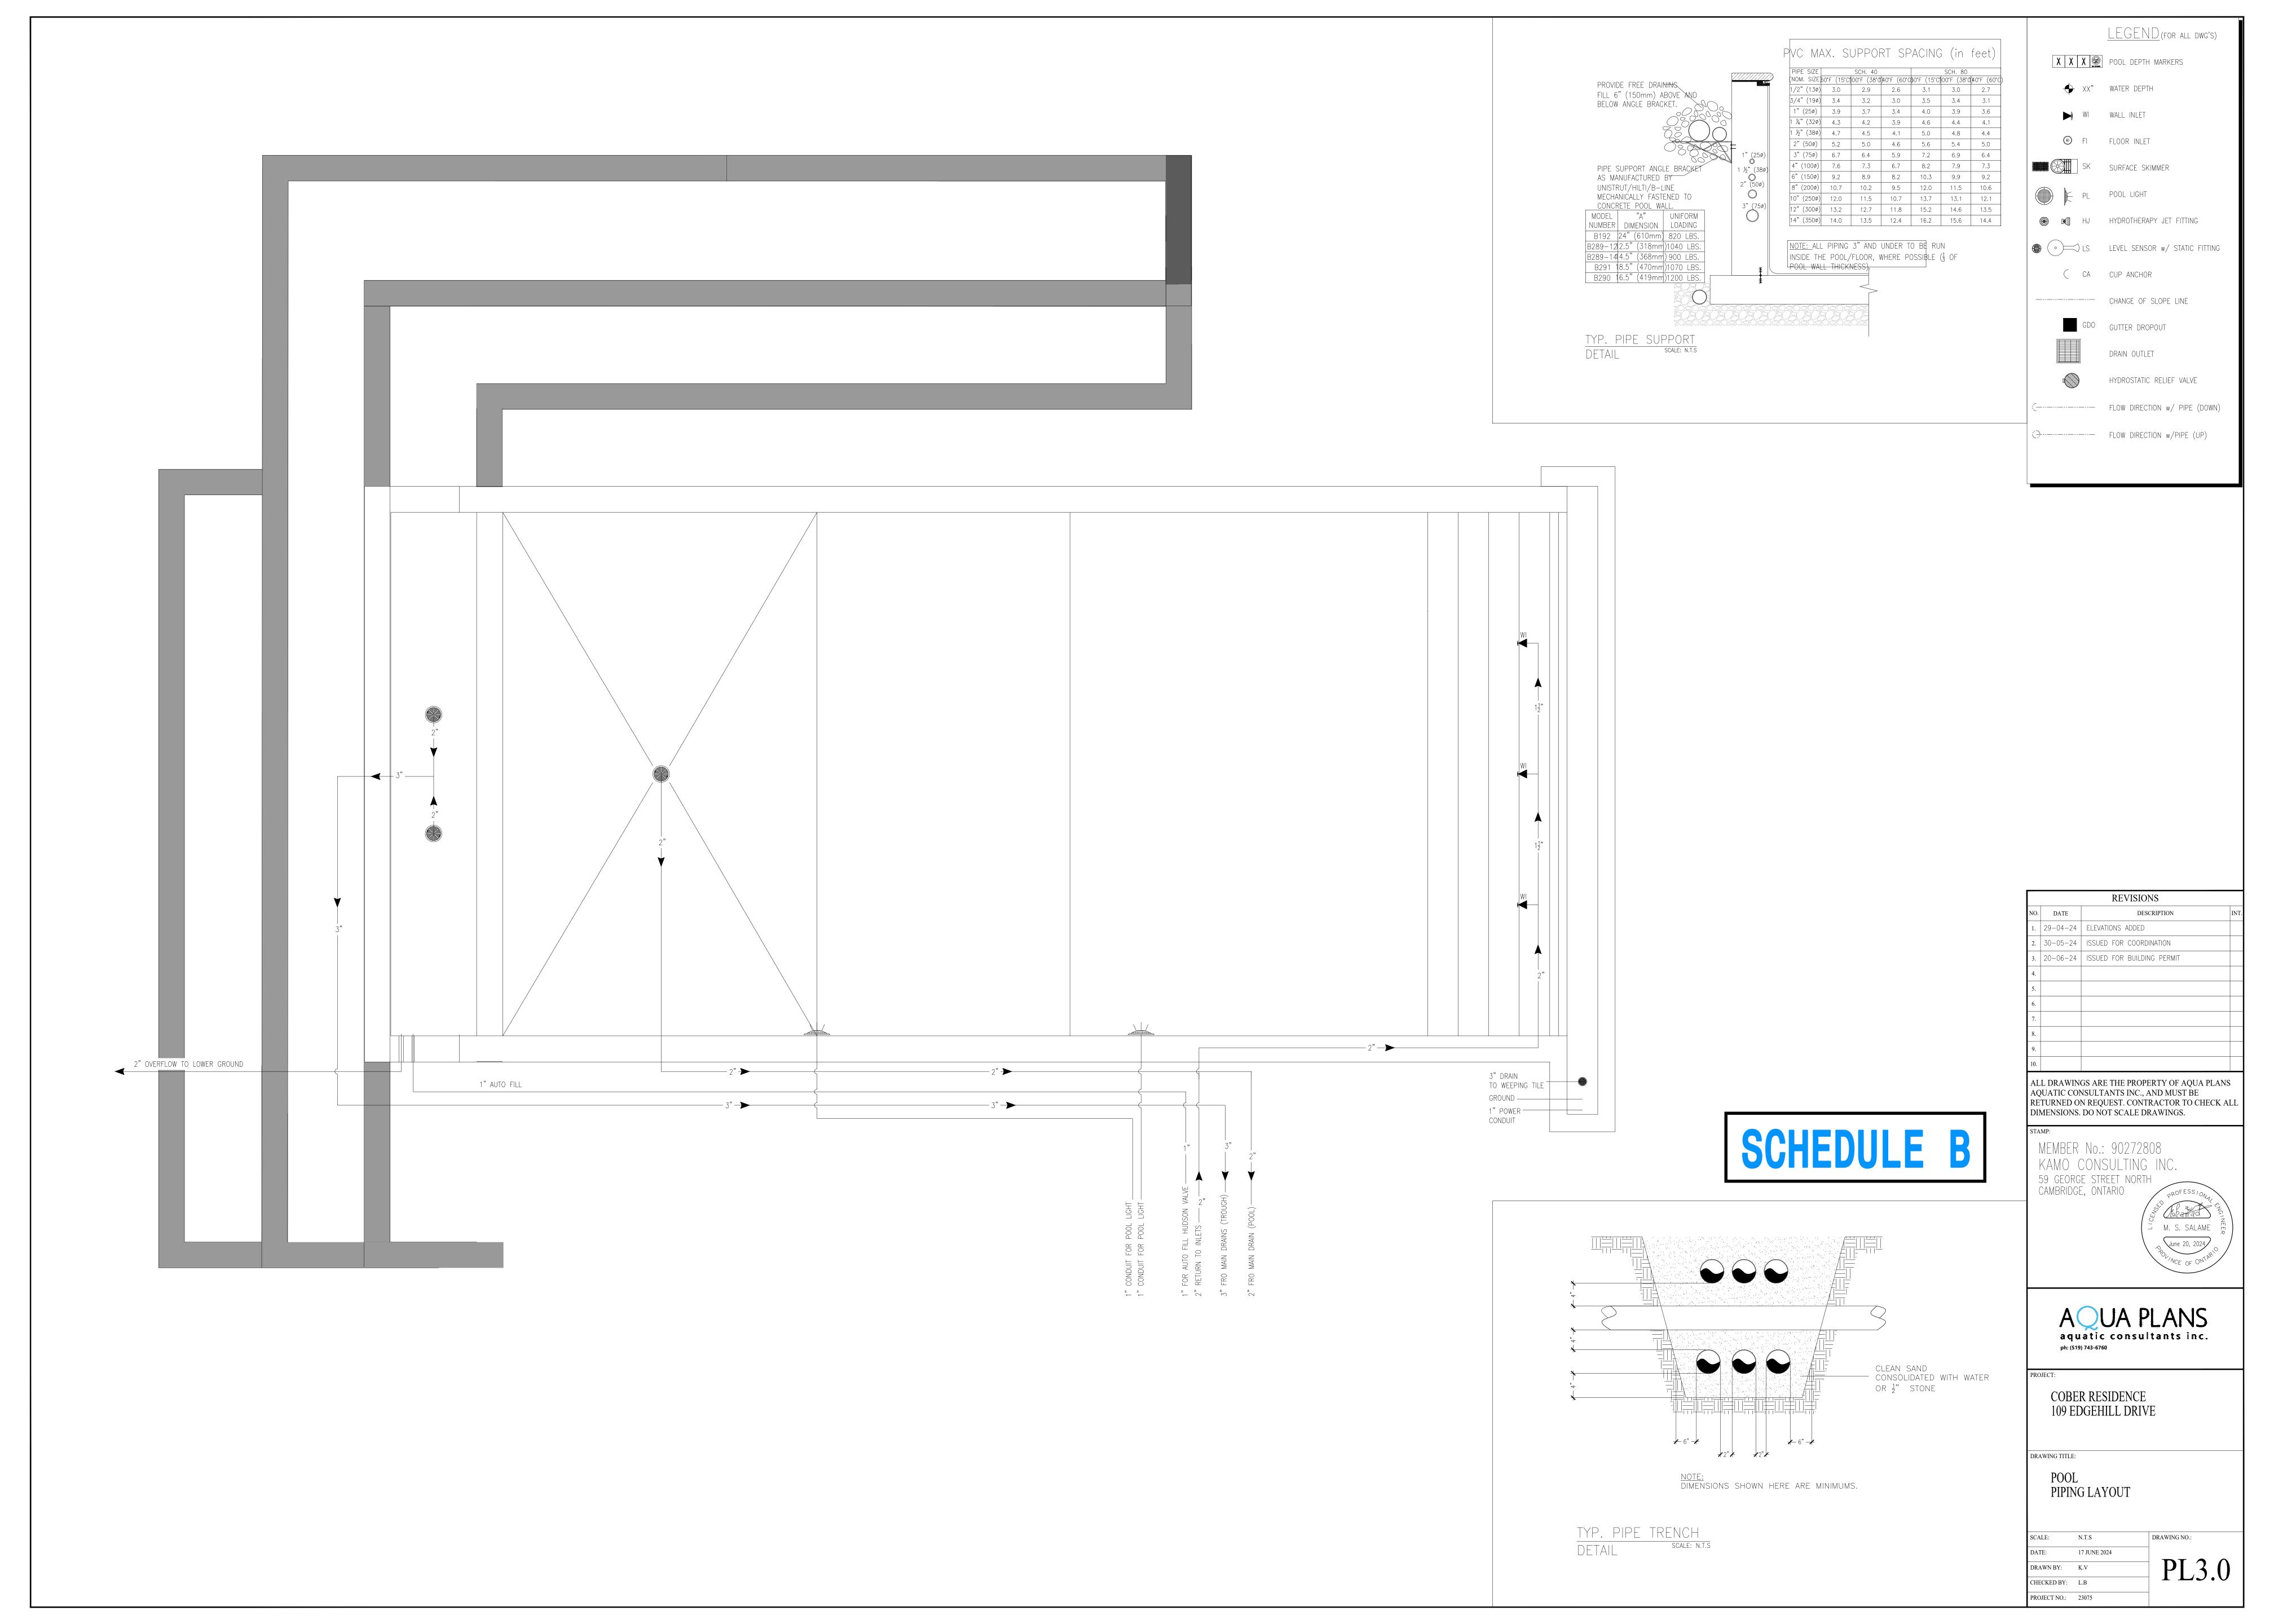

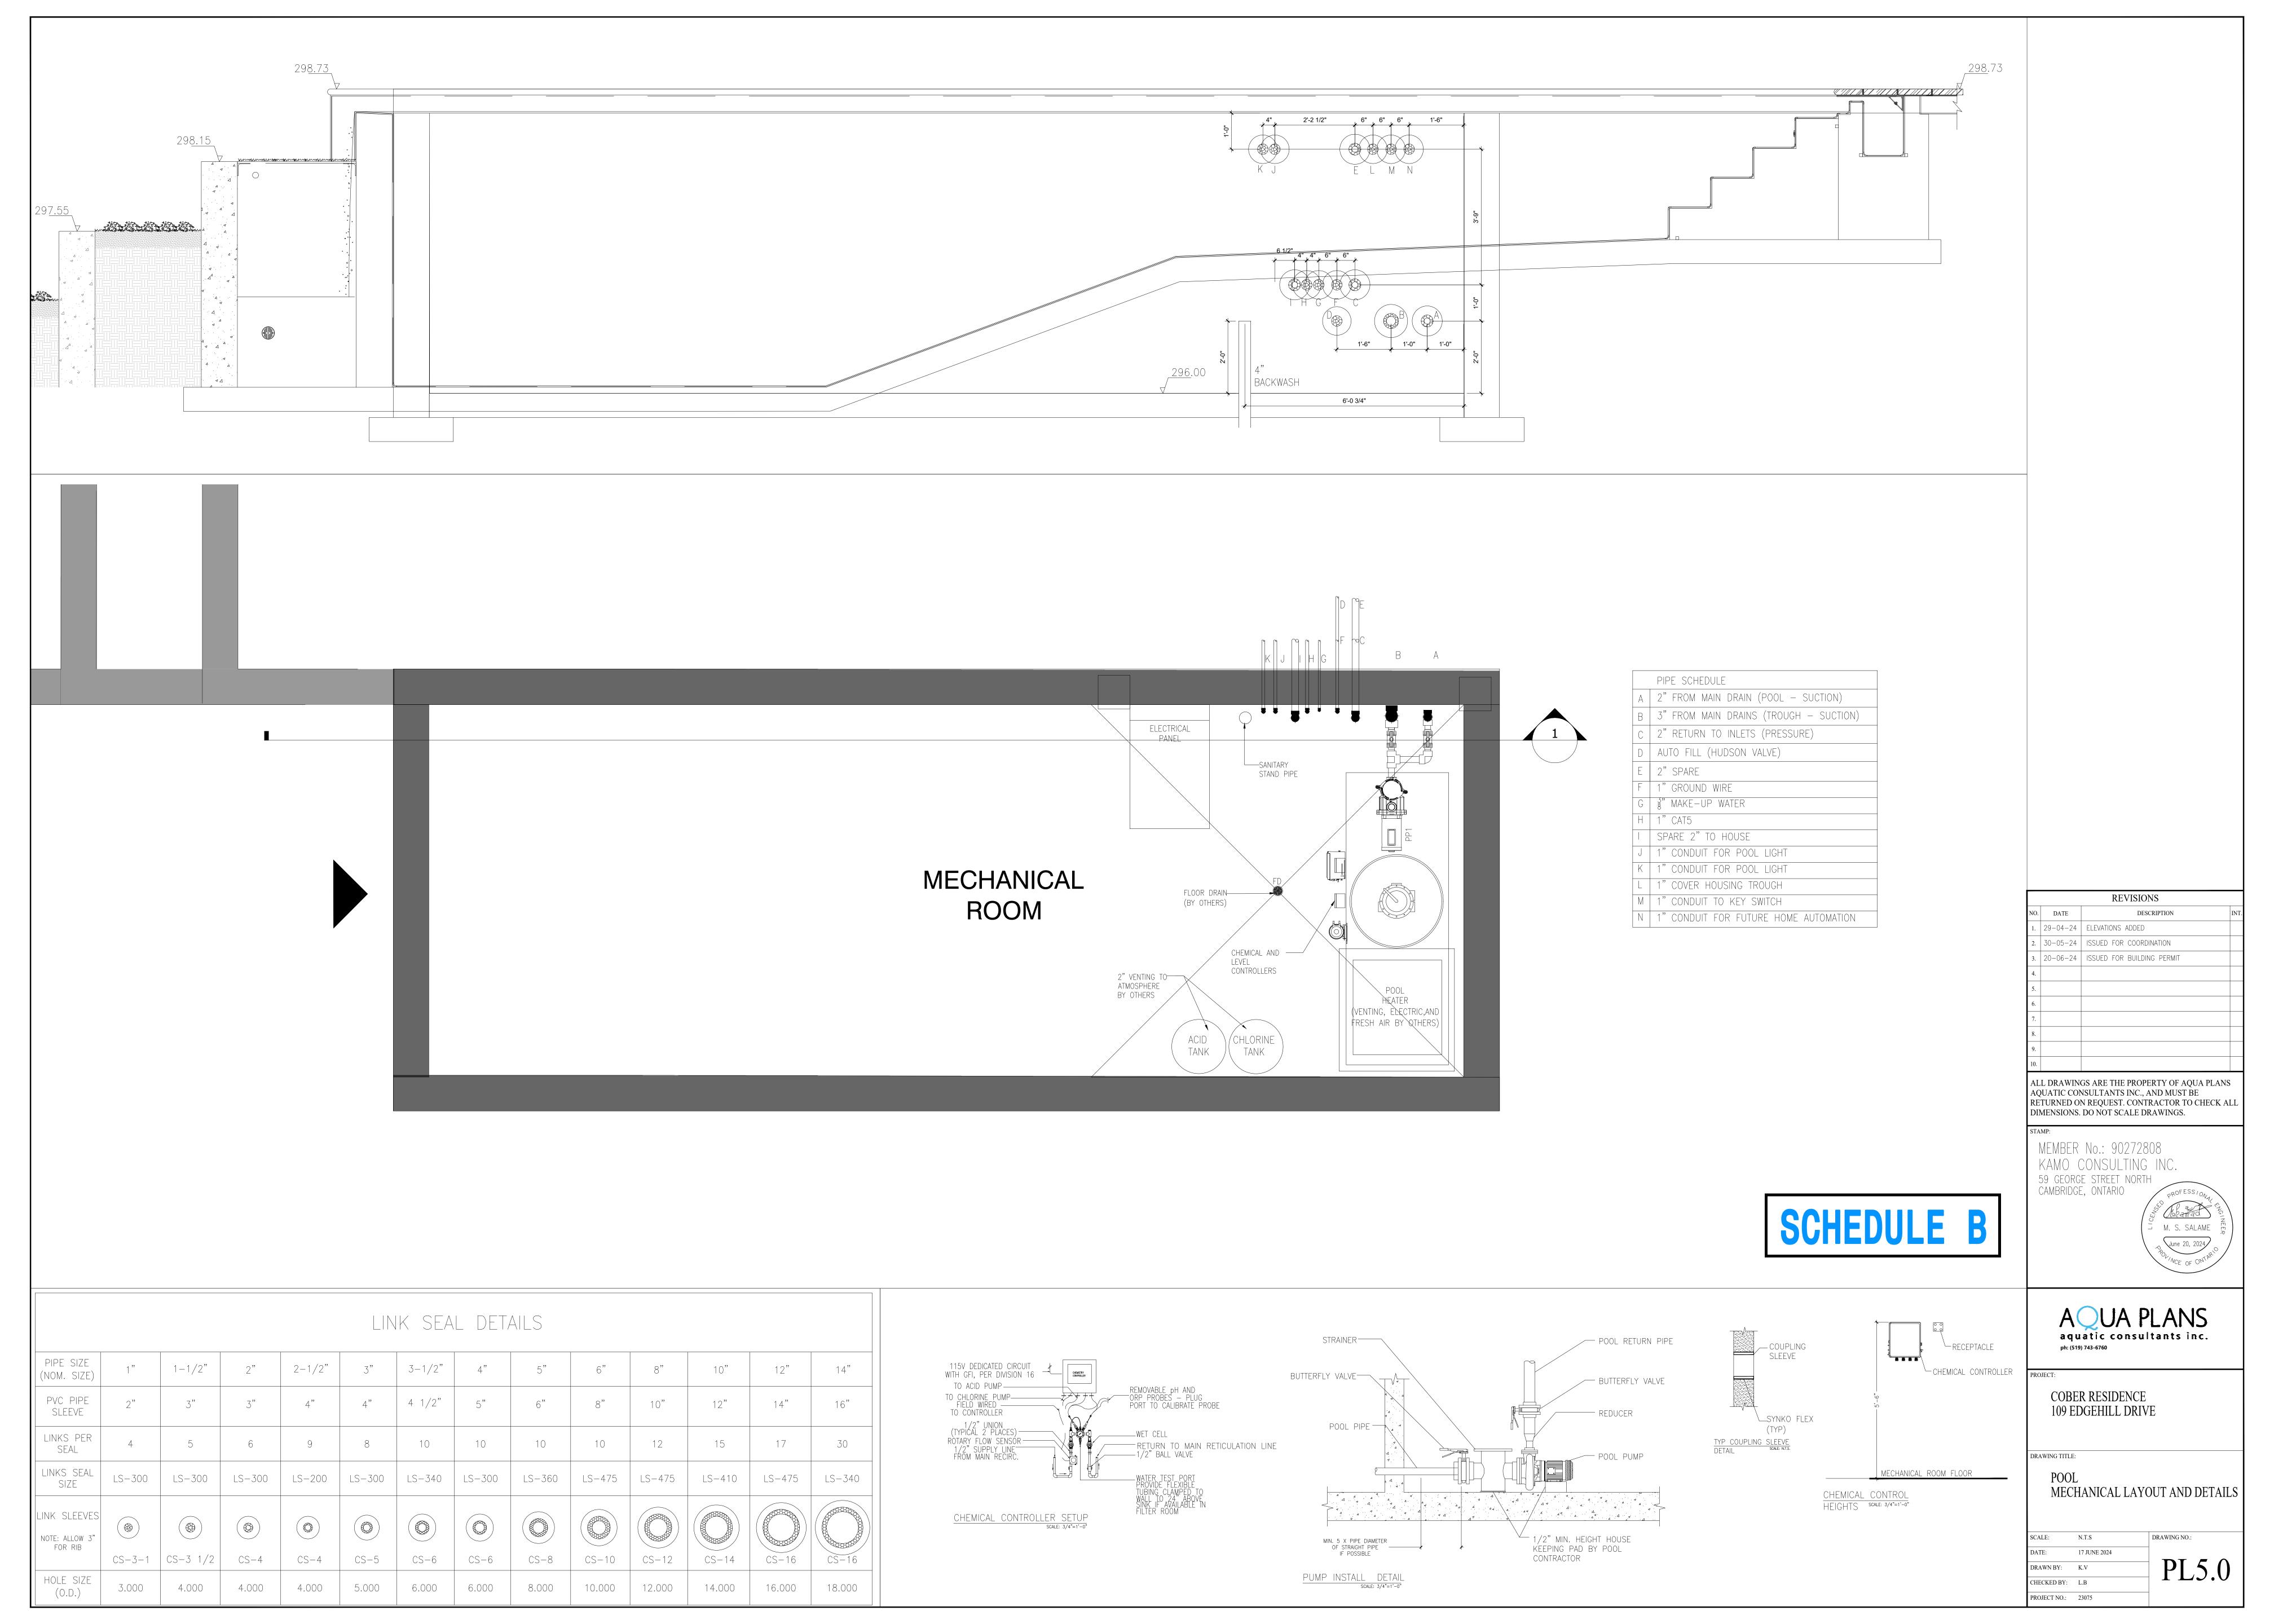

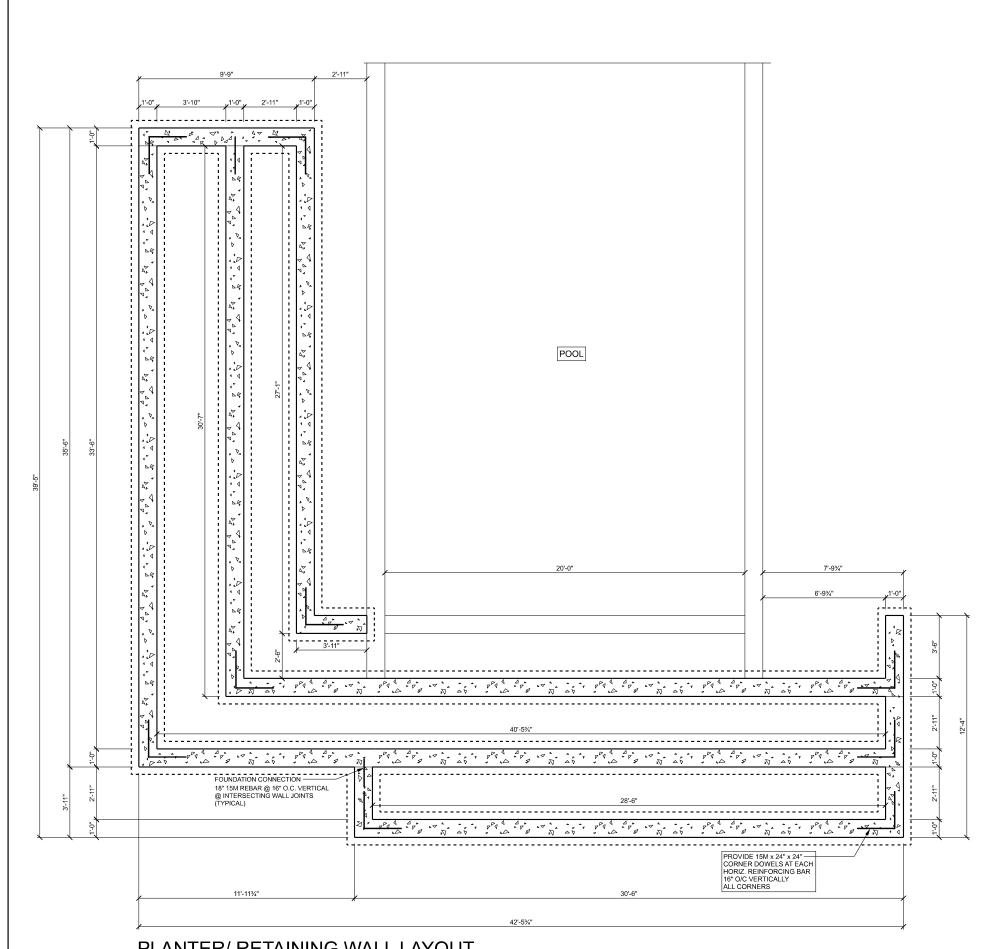

PLANTER/ RETAINING WALL LAYOUT

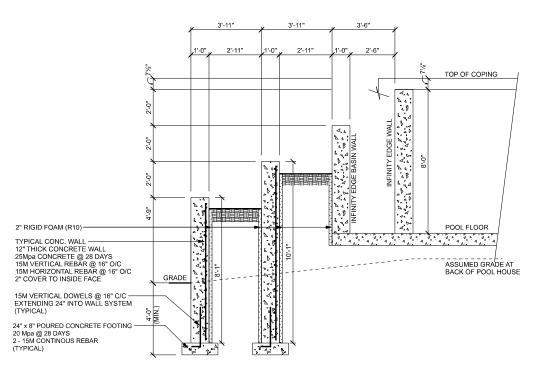







Kamo Consulting Inc. June 25, 2024

SCHEDULE B

SCALE: 3/16"=1'-0" DATE: Monday, June 24, 2024 PROJECT: PLANTER/ RETAINING WALLS LOT NO. 109 EDGE HILL DRIVE, KITCHENER DRAWINGS BY: M.T.




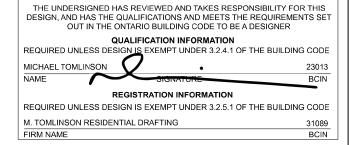

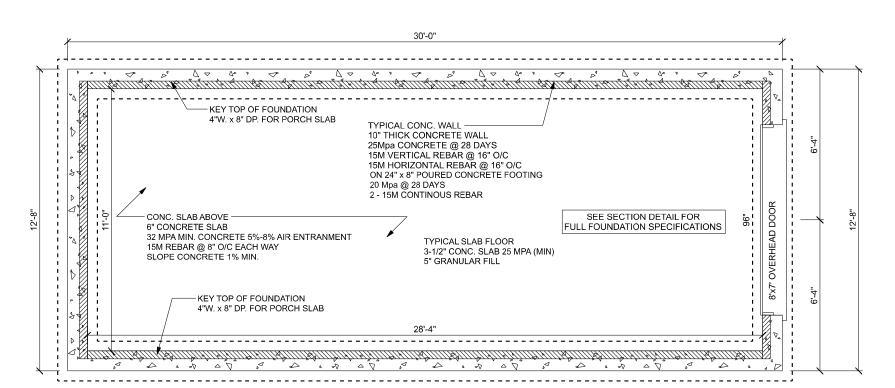

FOUNDATION PLAN

ALL CONCRETE WALLS 10" THICK UNLESS NOTED OTHERWISE

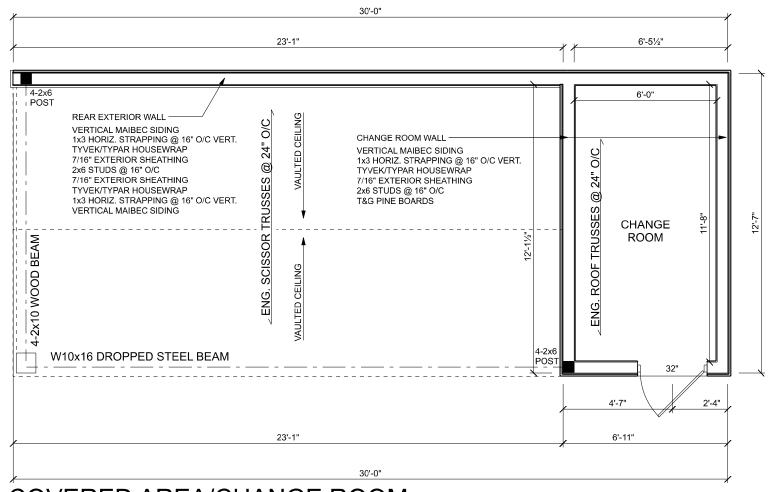

COVERED AREA/CHANGE ROOM

ALL EXTERIOR WALLS 2"x 6" @ 16" O.C. UNLESS NOTED OTHERWISE ALL STRUCTURAL LINTELS TO BE 2-2x10 UNLESS OTHERWISE NOTED

SCHEDULE B



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(519) 897-6322
mtrdrafting@gmail.com
-PROVIDING ONTARIO WITH DESIGN SOLUTIONS FOR 25 YEARS-

PROJECT: COVERED PATIO/CHANGE ROOM

DATE: Tuesday, May 21, 2024

PROJECT: COVERED PATIO/CHANGE ROOM

LOT NO. 109 EDGE HILL DRIVE, KITCHENER

DRAWINGS BY: M.T.

<u>A</u>1

