

HERITAGE PERMIT APPLICATION & SUBMISSION REQUIREMENTS

Development & Housing Approvals 200 King Street West, 6th Floor Kitchener ON N2G 4V6 519-741-2426; planning@kitchener.ca

ST	AFF USE ONLY			1		
D	ate Received:	Accepted	l By:	Applic	ation Number:	
				HPA-		
PA	ART B: HERITAGE PERM	IT APPLICATION	FORM			
1.	NATURE OF APPLICAT	ION				
	Exterior	□ Interior	🛛 Sig	nage		
		New Construct	tion 🗆 Alte	eration	C Relo	ocation
2.	SUBJECT PROPERTY Municipal Address: 1404 Legal Description (if know	Doon Village Road,	Kitchener PT UNNUMBERED	LOT RP 58R-929	99 PARTS 2&3	
	Building/Structure Type:					Institutional
	Heritage Designation:	□ Part IV (Individ	lual) 📕 Pai	t V (Heritage C	onservation Dis	strict)
	Is the property subject to	a Heritage Easem	ent or Agreement?	P □ Yes	i	No
3.	Name:					
	Address: 1404 Doon Villag	je Road				
	City/Province/Postal Code: Kitchener Ontario N2P 1A5					
	Phone:					
	Email:					
4.	AGENT (if applicable) Name:_ ^{Richard D'Alessand}	dro				
	Company:_NEO Architecture Inc.					
	Address: 270 King Street	t East				
	City/Province/Postal Cod	e: Kitchener Ontario	N2G 2L1			
	Phone: 519-590-0265					
	Email: richard@neoarchite	ecture.ca				

5. WRITTEN DESCRIPTION

Provide a written description of the project including any conservation methods proposed. Provide such detail as materials to be used, measurements, paint colours, decorative details, whether any original building fabric is to be removed or replaced, etc. Use additional pages as required. Please refer to the City of Kitchener Heritage Permit Application Submission Guidelines for further direction.

see Heritage Permit Application Supplemental, appended.

6. REVIEW OF CITY OF KITCHENER HERITAGE PERMIT APPLICATION SUBMISSION GUIDELINES

Describe why it is necessary to undertake the proposed work: see Heritage Permit Application Supplemental, appended.

Describe how the proposal is consistent with the Part IV individual designating by-law or the Part V Heritage Conservation District Plan:

see Heritage Permit Application Supplemental, appended.

Describe how the proposal is consistent with Parks Canada's *Standards and Guidelines for the Conservation of Historic Places in Canada* (www.historicplaces.ca/en/pages/standards-normes.aspx): see Heritage Permit Application Supplemental, appended.

7. PROPOSED WORKS

a)	Expected start date: May 9, 2025	Expected completion date:	December 31, 2025
b)	Have you discussed this work with Heritage Planni Michalle Drake, Sani	ng Staff? Yes	□ No
	- If yes, who did you speak to? Michelle Drake, Seni	or Hentage Planner	
c)	Have you discussed this work with Building Division	n Staff? Yes	🗆 No
	- If yes, who did you speak to? Sheryl Rice Menezes	s, Senior Planning Technician	
d)	Have you applied for a Building Permit for this work		□ No
e)	Other related Building or Planning applications:	Application number 25-106	755

8. ACKNOWLEDGEMENT

The undersigned acknowledges that all of the statements contained in documents filed in support of this application shall be deemed part of this application. The undersigned acknowledges that receipt of this application by the City of Kitchener - Planning Division does not guarantee it to be a 'complete' application. The undersigned acknowledges that the Council of the City of Kitchener shall determine whether the information submitted forms a complete application. Further review of the application will be undertaken and the owner or agent may be contacted to provide additional information and/or resolve any discrepancies or issues with the application as submitted. Once the application is deemed to be fully complete, the application will be processed and, if necessary, scheduled for the next available Heritage Kitchener committee and Council meeting. Submission of this application constitutes consent for authorized municipal staff to enter upon the subject property for the purpose of conducting site visits, including taking photographs, which are necessary for the evaluation of this application. The undersigned acknowledges that where an agent has been identified, the municipality is authorized but not required to contact this person in lieu of the owner and this person is authorized to act on behalf of the owner for all matters respecting the application. The undersigned agrees that the proposed work shall be done in accordance with this application and understands that the approval of this application under the Ontario Heritage Act shall not be a waiver of any of the provisions of any by-law of the City of Kitchener or legislation including but not limited to the requirements of the Building Code and the Zoning By-law. The undersigned acknowledges that in the event this application is approved, any departure from the conditions imposed by the Council of the City of Kitchener or from the plans or specifications approved by the Council of the City of Kitchener is prohibited and could result in a fine being imposed or imprisonment as provided for under the Ontario Heritage Act.

Signature of Owner/Agent:______

Signature of Owner/Agent:

9. AUTHORIZATION

If this application is being made by an agent on behalf of the property owner, the following authorization must be completed:

I / We, Peggy Reitzel 9 , owner of the land that is subject of this application,

hereby authorize Richard D'Alessandro, NEO Architecture Inc.

Signature of Owner/Agent:

Signature of Owner/Agent:

	to act on my	/ourb	ehalf in thi	s regard.
Date:	harch	31,	2025	5
Date:				

Date:

Date: March 31, 2025

The personal information on this form is collected under the legal authority of Section 33(2), Section 42(2), and Section 42(2.2) of the Ontario Heritage Act. The information will be used for the purposes of administering the Heritage Permit Application and ensuring appropriate service of notice of receipt under Section 33(3) and Section 42(3) of the Ontario Heritage Act. If you have any questions about this collection of personal information, please contact the Manager of Corporate Records, Legislated Services Division, City of Kitchener (519-741-2769).

STAFF USE ONLY

Application Number:
Application Received:
Application Complete:
Notice of Receipt:
Notice of Decision:
90-Day Expiry Date:
PROCESS:
Heritage Planning Staff:
Heritage Kitchener:

A city for everyone

-9299 PARTS 2&3

March 31, 2025

Development & Housing Approvals

200 King Street West, 6th Floor Kitchener, ON N2G 4V6 planning@kitchener.ca (519)-741-2426 Attn: Michelle Drake

RE: Heritage Permit Application

Municipal Address :	1404 Doon Village Road, Kitchener
Legal Description:	TRACT BIEHNS PT UNNUMBERED LOT RP 58R-9299 PARTS 2&3
Owner:	
Agent:	Richard D'Alessandro, NEO Architecture Inc. richard@neoarchitecture.ca 519-590-0265
Assigned Staff:	Michelle Drake, Senior Heritage Planner michelle.drake@kitchener.ca 519-783-8909

5. Written Description:

The application herein is for a proposed 1991.22sqft (184.99sqm) 1-Storey Rear Addition to an existing 1-Storey Non-Historic House (single-detached dwelling) constructed in 1994. The necessary Permit has already been granted by GRCA for construction within the 2-Zone Flood Fringe, and a Building Permit Application is under review by the City of Kitchener Building Department.

6. Review of City of Kitchener Heritage Permit Application Submission Guidelines

Describe why it is necessary to undertake the proposed work:

The proposed work is necessary in order to facilitate the expansion and enhancement of an existing but relatively new house (non historic building) by its resident - which is their right - for the sole purpose of enjoying more of the natural setting for which the Village is known. Afterall, there is no sense in preserving what we can only enjoy by means that are prohibited.

"While a primary objective of the plan is to conserve the natural and man-made heritage of Upper Doon, it is not the intention to create a museum-like character. On the contrary, it is vital that the Village remain a living and vibrant part of the City." (UDHCDP section 4.3 Economic Objectives)



neoarchitecture.ca

270 King St E., Kitchener ON, N2C 2L1 | 519 590 1636

Describe how the proposal is consistent with the Part IV individual designating by-law or the Part V Heritage Conservation District Plan:

The proposal herein is consistent with the intent of the Upper Doon Heritage Conservation District Plan (UDHCDP), which is to guide future development within the Village to ensure that the intrinsic heritage qualities of the district are preserved and enhanced (section 2 subsection ii).

Worth particular consideration is the following excerpt from UDHCDP subsection 5.9.3. iii) Policies for New Building:

"It is not the intent or desire that new building should reproduce past building styles. It is vital that the historic character of the Village remain 'honest' and not become a self-conscious historic pastiche. In this regard new building should be of good contemporary design and complementary to the height, proportion, scale and character of the district. The natural environment of Upper Doon is also a feature to which new building design should respond to with an emphasis on natural building form and materials.

In accordance with the criteria outlined in section 5.9.3. of the UDHCDP and subsection iii) for New Building:

The proposed is a rear addition of lesser size and height, located entirely behind and obscured by the existing house to which it is being added. As shown by the Exterior Renderings provided, the proposed addition will be rarely if at all visible from the street, obscured as it is by existing trees and the existing house itself. The character and quality of the streetscape, therefore, will remain unaffected.

Through both its placement and exterior treatment, the addition will appear as a mirage; where the addition is visible, only just barely and from rather extreme angles, the prior state of the house as well as the established streetscape are all the more apparent, thus preserving the likeness of both.

The roof(s), windows, materials and colours of the proposed addition are of good contemporary design that complement the existing house, as opposed to a misguided attempt at copying it or those like it.

We firmly believe that this is how we must treat all new buildings, in the shadow of those historic; for every brick or board that goes up now in their likeness, makes those bricks and boards that went up then less special and worth less.

Sameness, for the sake of preserving uniqueness is counterproductive.



Also noteworthy is the following excerpt from UDHCDP subsection 5.9.3. iii) Policies for New Building:

"Indeed appropriate and complementary design of new building is as important to conserving the character of the Village as the restoration of the historic building stock. Upper Doon is distinctly different from the enclosing new residential subdivisions and to import new subdivision house design would be to diminish its special and individual charm."

For the purposes of preserving natural heritage in the Village, it would be hard to argue that the UDHCDP hasn't been successful with respect to guiding density and uses of new building. Arguably less successful, has been its implementation since 1988 for the purposes of guiding the appearance of new building, with respect to the uniqueness of the Village and the statement above.

Contemporary design unadulterated, for a building constructed in the year 2025 as sure as those constructed in the 19th century, in keeping with the times, is the only way to preserve the genuine past without forgoing the genuine future.

Describe how the proposal is consistent with Parks Canada's Standards and Guidelines for the Conservation of Historic Places in Canada:

Inasmuch as the Upper Doon Heritage Conservation District Plan (UDHCDP) objectives and policies are consistent with Parks Canada's Standards and Guidelines for the Conservation of Historic Places in Canada, which they surely are, the proposed is consistent by way of responding to the UDHCDP.

Please contact us immediately if there are any questions or concerns related to this proposal or the information on which it is based.

Sincerely,

NEO Architecture Inc.

RICHARD D'ALESSANDRO ASSOCIATE




KEYNOTE LEGEND

3.01A	PREFINISHED VERTICAL METAL SIDING (MANUFACTURER: METALUNIC / VICWEST) (STYLE: MODERNO / BELLARA PLANK) (SERIES: WOODSHADE / EXPRESSENCE) (COLOUR: URBAN GREY 783 QC182535 / RIVER ROCK GRAY 18-0254) OR SIMILAR & APPROVED ALTERNATE
3.01B	PREFINISHED VERTICAL STANDING SEAM METAL ROOFING (MANUFACTURER: IDEAL ROODING / AGWAY) (STYLE: HERITAGE SERIES, STIFFENER RIBS REMOVED / AR STANDING SEAM, NO STIFFENER FLUTES) (COLOUR: JET BLACK TEXTURED ID 60039 / EBONY WRINKLE COAT QC 09822) OR SIMILAR & APPROVED ALTERNATE
3.02A	PREFINISHED VINYL SLIDING DOOR. OPERABLE PANEL SHOWN w/ DASHED LINES. REFER TO DOOR SCHEDULE & ELEVATIONS FOR DETAILS.
3.02C	THERMALLY BROKEN EXTRUDED ALUMINUM WINDOW WALL FRAME SYSTEM C/W INSULATED SEALED DOUBLE GLAZING
3.03	PREFINISHED BENT METAL FLASHING (COLOUR: TBD, TO MATCH SIDING BELOW)
3.04	PREFINISHED METAL RIDGE CAP (COLOUR: TO MATCH ROOFING)
3.05	CONCRETE FOUNDATION WALL (FINISH: SANDBLASTED)
3.06	TEMPERED GLASS GUARDRAIL c/w PREFINISHED EXTRUDED ALUMINUM POSTS AND TOP & BOTTOM RAIL(S). REFER TO SECTIONS FOR HEIGHT REQUIREMENTS. (MANUFACTURER: GRECO) (PROFILE: C12 C/W GAR-R7 TOP RAIL) (COLOUR: GAR 800 GREY)
3.08	PREFINISHED FIBER-CEMENT PANEL (MANUFACTURER: JAMESHARDIE) (FINISH: SMOOTH) (SERIES: STATEMENT COLLECTION) (COLOUR: MIDNIGHT BLACK)

U/S Ex. Ftg 938' - 7 1/2"

Mar 28/25	Issued for Heritage Permit
Mar 14/25	Issued for Building Permit
Dec 03/24	Issued for Budget Costing
Nov 4/24	Issued for Coordination
Oct 22/24	Issued for Coordination
Sept 27/24	Issued for Coordination
DATE	ISSUE
	Dec 03/24 Nov 4/24 Oct 22/24 Sept 27/24



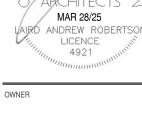

1404 Doon Village Road, Kitchener On, N2P 1A5 PROJECT 1404 Doon Village Oasis

1404 Doon Village Road, Kitchener On, N2P 1A5

Building Elevations

PROJECT No. 24-008 PROJECT DATE September 23, 2024 DRAWN BY A301 zschickler



KEYNOTE LEGEND

3.01A	PREFINISHED VERTICAL METAL SIDING (MANUFACTURER: METALUNIC / VICWEST) (STYLE: MODERNO / BELLARA PLANK) (SERIES: WOODSHADE / EXPRESSENCE) (COLOUR: URBAN GREY 783 QC182535 / RIVER ROCK GRAY 18-0254)
3.01B	OR SIMILAR & APPROVED ALTERNATE PREFINISHED VERTICAL STANDING SEAM METAL ROOFING (MANUFACTURER: IDEAL ROODING / AGWAY) (STYLE: HERITAGE SERIES, STIFFENER RIBS REMOVED / AR STANDING SEAM, NO STIFFENER FLUTES) (COLOUR: JET BLACK TEXTURED ID 60039 / EBONY WRINKLE COAT QC 09822) OR SIMILAR & APPROVED ALTERNATE
3.02B	PREFINISHED ALUMINUM ENTRY DOOR SYSTEM c/w STEEL INSULATED DOOR PANEL. REFER TO DOOR SCHEDULE & ELEVATIONS FOR DETAILS.
3.02C	THERMALLY BROKEN EXTRUDED ALUMINUM WINDOW WALL FRAME SYSTEM C/W INSULATED SEALED DOUBLE GLAZING
3.02D	THERMALLY BROKEN EXTRUDED ALUMINUM SKYLIGHT FRAME SYSTEM C/W INSULATED SEALED DOUBLE GLAZING
3.03	PREFINISHED BENT METAL FLASHING (COLOUR: TBD, TO MATCH SIDING BELOW)
3.04	PREFINISHED METAL RIDGE CAP (COLOUR: TO MATCH ROOFING)
3.05	CONCRETE FOUNDATION WALL (FINISH: SANDBLASTED)
3.06	TEMPERED GLASS GUARDRAIL c/w PREFINISHED EXTRUDED ALUMINUM POSTS AND TOP & BOTTOM RAIL(S). REFER TO SECTIONS FOR HEIGHT REQUIREMENTS. (MANUFACTURER: GRECO) (PROFILE: C12 C/W GAR-R7 TOP RAIL) (COLOUR: GAR 800 GREY)
3.07	PREFINISHED VERTICAL STANDING SEAM METAL ROOF (MANUFACTURER: TBD/ STYLE: TBD/ COLOUR: DARK GREY)
3.08	PREFINISHED FIBER-CEMENT PANEL (MANUFACTURER: JAMESHARDIE) (FINISH: SMOOTH) (SERIES: STATEMENT COLLECTION) (COLOUR: MIDNIGHT BLACK)

BUILDING PERMIT

8	Mar 28/25	Issued for Heritage Permit
7	Mar 14/25	Issued for Building Permit
6	Dec 03/24	Issued for Budget Costing
3	Nov 4/24	Issued for Coordination
2	Oct 22/24	Issued for Coordination
1	Sept 27/24	Issued for Coordination
No.	DATE	ISSUE



1404 Doon Village Road, Kitchener On, N2P 1A5 PROJECT 1404 Doon Village Oasis

1404 Doon Village Road, Kitchener On, N2P 1A5

Building Elevations


PROJECT No.	
24-008	
PROJECT DATE	
September 23, 2024	A300
DRAWN BY	
zschickler	

1404 Doon Village Oasis 1404 Doon Village Rd., Kitchener Ontario



DRAWING LIST

ARCH	TECTURAL		
DWG. No.:	DWG. Name:	REV#:	DATE:
A00 - PROJI A000	ECT INFORMATION Cover Sheet	7	Mar 14/25
A000	General Notes	7	Mar 14/25
A002	Code Compliance Matrix	7	Mar 14/25
A10 - SITE			
A100	Site Plan	7	Mar 14/25
A20 - PLANS	5 Foundation Plan	7	Max 14/05
A200 A201	Proposed Ground Floor Plan	7	Mar 14/25 Mar 14/25
A201 A203	Roof Plan	7	Mar 14/25
		1	
A21 - ENLAF	RGED PLANS		
A210	Enlarged Floor Plans	7	Mar 14/25
	ECTED CEILING PLANS		
A250	Reflected Ceiling Plan	7	Mar 14/25
A30 - ELEVA	NTIONS		
A300	Building Elevations	7	Mar 14/25
A301	Building Elevations	7	Mar 14/25
A35 - BUILD	ING SECTIONS		
A350	Building Sections	7	Mar 14/25
A40 - WALL		~	Max 14/05
A400 A401	Wall Sections Wall Sections	7	Mar 14/25 Mar 14/25
A401	waii Sections	1	iviai 14/20
A55 - INTER	IOR ELEVATIONS		
A550	Interior Elevations	7	Mar 14/25
A75 - SECTI	ON DETAILS		
A750	Section Details	7	Mar 14/25
A80 - SCHE		~	Marttor
A800	Door & Window Schedule	7	Mar 14/25
D20 - DEMC	LITION		
D20 - DEIVIC	Demolition Plans	7	Mar 14/25
		1	

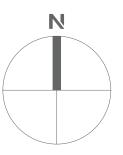

BUILDING PERMIT

7	Mar 14/25	Issued for Building Permit
6	Dec 03/24	Issued for Budget Costing
No.	DATE	ISSUE
		ARCHITECTURE INC
		270 King St E., Kitchener ON, N2G 2L1 519 590 1636 neoarchitecture.ca




1404 Doon Village Road, Kitchener On, N2P 1A5 PROJECT 1404 Doon Village Oasis

1404 Doon Village Road, Kitchener On, N2P 1A5


Cover Sheet

OWNER

PROJECT NO. 24-008	
PROJECT DATE	
September 23, 2024	
DRAWN BY	
zschickler	

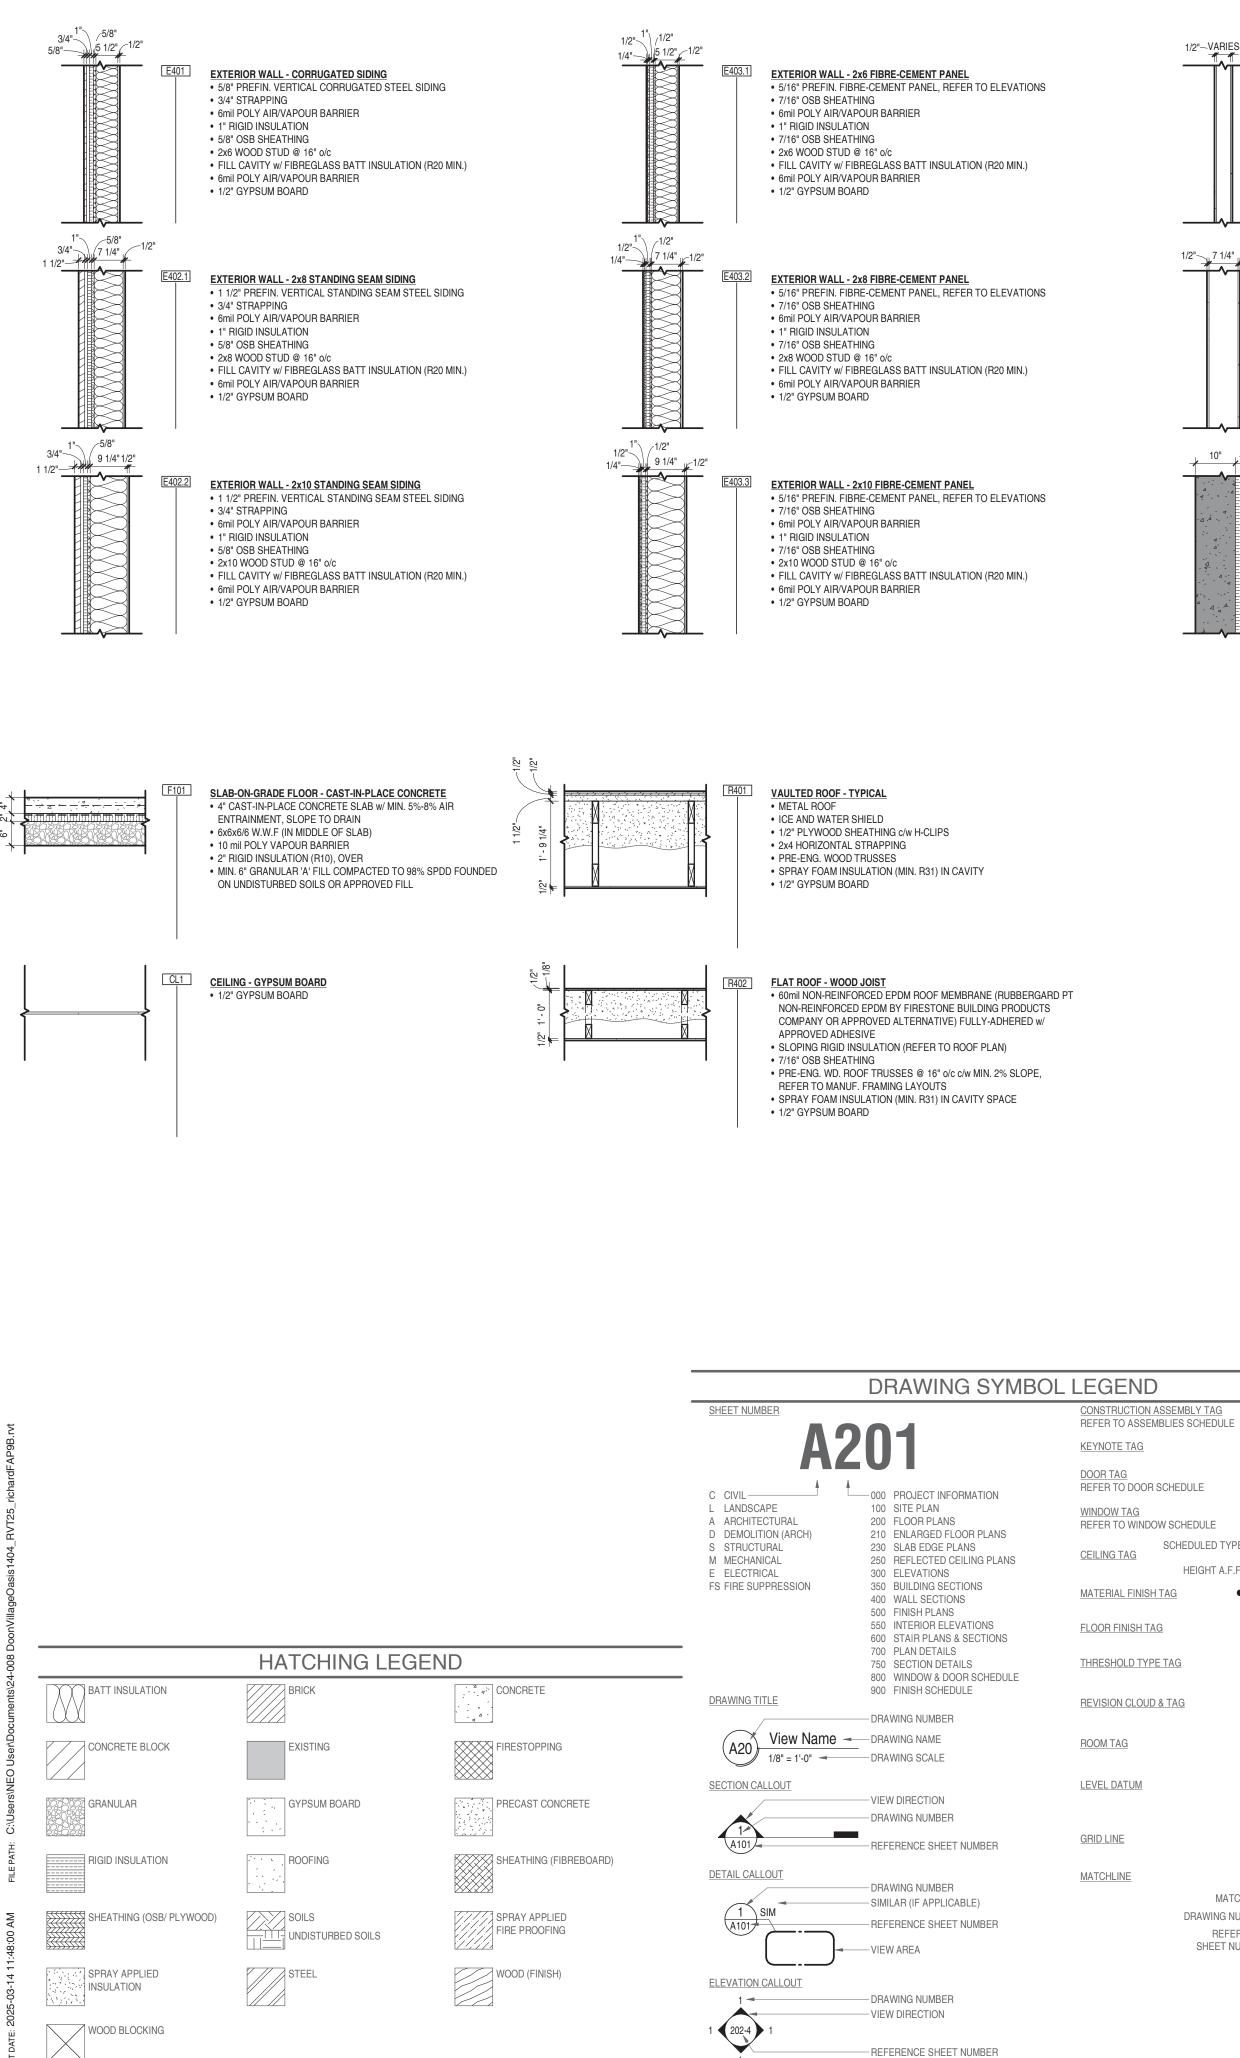



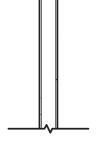

W402

CLG 2750

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MATCHLINE ----


DRAWING NUMBER-

REFERENCE SHEET NUMBER

• PT-1

SCHEDULED TYPE-

HEIGHT A.F.F.-

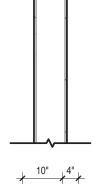

PARTITION - 2x8 WOOD STUD • 1/2" GYPSUM BOARD • 2x8 WOOD STUDS @ 16" o/c 1/2" GYPSUM BOARD

PARTITION - WOOD STUD

• 2x4 OR 2x6 WOOD STUDS @ 16" o/c,

REFER TO PLANS FOR SIZING

• 1/2" GYPSUM BOARD

1/2" GYPSUM BOARD

FOUNDATION WALL 10" • 10" CAST-IN-PLACE CONCRETE, REFER TO FOUNDATION PLANS FOR REINFORCING REQUIREMENTS • 4" (R20 MIN.) RIGID INSULATION

			HEATED SPACE
			SEMI-HEATED SPACE
			R20 c.i. (BASEMENT WALLS)
			R20 c.i. (WALLS, ABOVE GRADE - MASS
			R13 + R15 c.i. (WALLS, ABOVE GRADE - STEEL FRAMED)
			R35 c.i. (ROOF, INSULATION ENTIRELY ABOVE DECK)
	EN	ERGY [DESIGN NOTES
	٦	ABLE SB 5.5-6-2	ARE REFERENCED FROM OBC SB-10 2017, BUILDING ENVELOPE FOR CLIMATE ZONE 6 (A, B) (I-P).
	2. A F	ALL FENESTRAT	ION AND ELEMENTS NOT VISIBLE IN TO COMPLY WITH THE ABOVE NOTED
	CE	ILING I	PLAN LEGEND
	0	POT LIGHT, SE	E ELEC. DWGS.
	۲	DIRECTIONAL	POT LIGHT, SEE ELEC. DWGS.
	0		ITED LIGHT FIXTURE, SEE ELEC. DWGS.
	μX		ED LIGHT FIXTURE, SEE ELEC. DWGS.
			GHT FIXTURE, SEE ELEC. DWGS.
	LJ N		IGHT FIXTURE, SEE ELEC. DWGS. , SEE MECH. DWGS.
•			IFFUSER, SEE MECH. DWGS.
		RETURN AIR G	RILLE, SEE MECH. DWGS.
		LINEAR SUPPL	Y AIR DIFFUSER, SEE MECH. DWGS.
		FIRE SPRAY IN	ISULATION AT U/S OF STRUCTURE
	CLG		ING TYPE AND CEILING HEIGHT, Y SCHEDULE
	(2750)		

ENERGY DESIGN LEGEND

GENERAL NOTES

- 1. DO NOT SCALE DRAWINGS.
- 2. THE DRAWINGS HEREIN ARE AN INSTRUMENT OF SERVICE & IS THE PROPERTY OF NEO ARCHITECTURE INC. & CANNOT BE MODIFIED AND/OR REPRODUCED WITHOUT THE WRITTEN CONSENT OF NEO ARCHITECTURE INC. 3. THE CONTRACTOR SHALL VERIFY ALL DIMENSIONS AND EXISTING CONDITIONS ON SITE AND SHALL REPORT ALL DISCREPANCIES
- TO THE CONSULTANT BEFORE PROCEEDING WITH THE WORK. 4. DRAWINGS ARE TO BE READ IN CONJUNCTION WITH THE CIVIL, LANDSCAPE, STRUCTURAL, MECHANICAL, ELECTRICAL DRAWINGS AND GEOTECHNICAL REPORTS, WHERE APPLICABLE. FURTHERMORE, ALL ARCHITECTURAL DRAWINGS ARE TO BE READ IN
- CONJUNCTION WITH THE FULL ARCHITECTURAL DRAWING SET, IN IT'S ENTIRETY. THE CONTRACTOR IS RESPONSIBLE FOR ENSURING ALL DRAWINGS ARE DISTRIBUTED TO ALL SUBCONTRACTORS. 5. ALL MATERIAL AND WORKMANSHIP SHALL COMPLY WITH ALL APPLICABLE CANADIAN CONSTRUCTION STANDARDS AND THE
- ONTARIO BUILDING CODE. 6. WORK SHALL BE PERFORMED IN A MANNER THAT WILL MINIMIZE THE INTERRUPTION OF ACCESS IN ALL AREAS AFFECTED BY
- CONSTRUCTION. EMERGENCY EXITING SHALL BE MAINTAINED AT ALL TIMES. 7. ALL CUTTING AND PATCHING OF EXISTING FINISHES WILL BE DONE TO THE HIGHEST STANDARD. COORDINATE THIS WORK WITH
- ALL CONTRACT DOCUMENTS. 8. ALL MATERIAL USED FOR NEW CONSTRUCTION SHALL BE NEW AND FREE OF DEFECTS. CONTRACTOR WILL BE RESPONSIBLE TO
- PATCH, REPAIR AND MAKE GOOD ALL AREAS AFFECTED BY THE WORK, INCLUDING MECHANICAL AND ELECTRICAL PATCH AND REPAIRS, TO THE SATISFACTION OF THE CONSULTANTS. 9. SUPPLY AND MAINTAIN ON A DAILY BASIS ALL INTERIOR AND EXTERIOR TEMPORARY COVERINGS, FENCING, TARPING,
- HOARDING, FLOOR PLATES, SIGNAGE AND OTHER SEPARATIONS REQUIRED TO MAINTAIN THE SAFETY OF THE PUBLIC AND PROVIDE ACCESS TO PUBLIC SPACES DURING THE WORK OF THIS CONTRACT. COORDINATE THESE PROTECTIVE MEASURES WITH OWNER AND ANY ADJACENT PROPERTIES IF NEEDED. REMOVE AND/OR DISPOSE OF ALL ITEMS NOTED FROM SITE AFTER COMPLETION OF THE CONTRACT WORK.
- 10. MAINTAIN A CLEAN AND ORDERLY SITE AT ALL TIMES.
- 11. COORDINATE WITH OWNER AREA(S) FOR GARBAGE BIN LOCATION. SUPPLY AND INSTALL PROTECTIVE MEASURES TO ENSURE THE GENERAL PUBLIC SAFETY. 12. COORDINATE WITH OWNER ANY STAGING OF WORK AND/OR DISRUPTION OF PARKING AND TRAFFIC FLOW.
- 13. IT IS THE RESPONSIBILITY OF THE GENERAL CONTRACTOR AND ALL THEIR SUBCONTRACTORS TO VISIT THE SITE AND FAMILIARIZE THEMSELVES WITH ALL ASPECTS OF THE PROJECT.
- 14. ALL NEW SIGNAGE TO BE COORDINATED WITH OWNER'S REQUIREMENTS. ALL PERMITS AND DRAWINGS BY OTHERS. 15. GENERAL CONTRACTOR TO PROVIDE AND MAINTAIN ALL SHORING THAT IS REQUIRED FOR TEMPORARY SUPPORTS.
- 16. INTERIOR DIMENSIONS ARE TAKEN FROM FACE OF FRAMING OR MASONRY OR FACE OF OPENINGS OR FACE OF EXISTING CONDITIONS UNLESS NOTED OTHERWISE. 17. PROVIDE CONCEALED BLOCKING AT ALL ACCESSORIES & CASEWORK LOCATIONS. EXTEND BLOCKING A MINIMUM OF 150mm
- BEYOND ALL SIDES, ABOVE AND BELOW. 18. ALL PENETRATIONS IN FIRE RATED WALLS MUST BE SEALED WITH APPROPRIATE FIRESTOPPING.
- 19. GENERAL CONTRACTOR SHALL RETAIN SERVICES OF A FIRESTOPPING COMPANY AND SUBMIT U.L.C. SYSTEM(S) PROPOSED FOR ALL PENETRATIONS THROUGH FIRE SEPARATIONS TO CONSULTANTS FOR APPROVAL PRIOR TO INSTALLATION OF FIRESTOPPING. THE FIRESTOPPING COMPANY SHALL PROVIDE A LETTER AT THE COMPLETION OF THE PROJECT STATING THAT THEY INSPECTED AND CERTIFY PROPER INSTALLATION.
- 20. SEE INTERIOR ELEVATIONS FOR LOCATIONS OF MISCELLANEOUS MECHANICAL & ELECTRICAL ITEMS. IF LOCATION IS NOT INDICATED ON ARCHITECTURAL DRAWINGS, REFER TO MECHANICAL & ELECTRICAL DRAWINGS FOR GENERAL LOCATIONS.
- 21. SHAFT WALLS ARE TO BE FULL HEIGHT AND SEALED TO UNDERSIDE OF ROOF. FIRESTOPPING TO HAVE RATING NOT LESS THAN SHAFT WALL.
- 22. ALL INTERIOR BLOCK WALL AND/OR PARTITIONS TO EXTEND FULL HEIGHT TO UNDERSIDE OF STRUCTURE ABOVE. CONTRACTOR TO PROVIDE COMPLETE SEAL AT ALL PENETRATIONS. PROVIDE DEFLECTION GAP AS REQUIRED.
- 23. GENERAL CONTRACTOR TO PROVIDE ENGINEERED STEEL STUD SHOP DRAWINGS. 24. SITE VERIFY ALL DIMENSIONS PRIOR TO FABRICATION OF DOORS, WINDOWS AND MILLWORK.
- 25. ALL WALLS, CEILINGS AND SURFACES THAT ARE TO BE PAINTED SHALL BE REPAIRED, PATCHED AND SANDED SMOOTH, AS REQUIRED, READY FOR PAINT.
- 26. PORTABLE FIRE EXTINGUISHERS TO BE INSTALLED IN CONFORMANCE WITH THE OFC 6.2 AND MUST HAVE A MINIMUM RATING OF 2A10BC AS PER MUNICIPAL BYLAW.
- 27. SUPPLY & INSTALL SEALANT AT LOCATIONS OF ABUTTING DISSIMILAR MATERIALS AND EQUIPMENT, VISIBLE OR OTHERWISE, TO PROTECT BUILDING COMPONENTS FROM AIR INFILTRATION AND MOISTURE PROTECTION. COLOUR TO MATCH ADJACENT SURFACE.
- 28. THE DRAWINGS INDICATE THE PHYSICAL DIMENSIONS, EXISTING LEVELS AND SIMILAR ITEMS BEING INDICATED WHERE KNOWN. ALL INFORMATION RELATIVE TO EXISTING CONDITIONS IS OFFERED TO ASSIST THE CONTRACTOR IN EVALUATION OF THE WORK, BUT WITH NO SPECIFIC REPRESENTATION EITHER EXPRESSED OR IMPLIED, AS TO COMPLETENESS OR ACCURACY, BE RESPONSIBLE FOR ANY DEDUCTIONS OR CONCLUSIONS MADE ON THE BASIS OF THIS INFORMATION AND THAT OF ANY ADDITIONAL SITE INSPECTIONS, IF MADE.
- 29. ALL INTERIOR CONCRETE BLOCK WALLS TO EXTEND FULL HEIGHT TO U/S OF STRUCTURE UNLESS NOTED OTHERWISE. PROVIDE FOR DEFLECTION GAP AS REQUIRED.
- 30. GENERAL CONTRACTOR TO VERIFY ELEVATOR SHAFT SIZE PRIOR TO CONSTRUCTION WITH APPROVED SHOP DRAWINGS. 31. ALL AREAS DESIGNATED AS MECHANICAL SPACE TO RECEIVE FIRE STOPPING AND DAMPERS AT ALL FLOOR PENETRATIONS. 32. THE CONTRACTOR SHALL ENSURE THAT ALL PORTIONS OF EXPOSED FOUNDATION WALLS ARE TO BE CAREFULLY FORMED AND
- POURED AND THAT ALL SURFACE IMPERFECTIONS, SCUFFS, CHIPS, ABRASIONS, INCLUDING FORM TIES ARE REMOVED AND THE SURFACE IS MADE GOOD.
- 33. ALL EXTERIOR EXPOSED ARCHITECTURAL CONCRETE SURFACES TO BE SEALED. 34. RELACE 13mm GYPSUM BOARD WITH 16mm GYPSUM BOARD IN NECESSARY LOCATIONS TO KEEP GYPSUM BOARD THICKNESS
- CONSISTENT 35. ALL GYPSUM BOARD IN ALL WASHROOMS, KITCHENS, AND MECHANICAL/ELECTRICAL ROOMS IS TO BE MOISTURE RESISTANT
- GYPSUM BOARD AS SPECIFIED. 36. ALL GYPSUM BOARD IN SHOWER AREAS IS TO BE MOISTURE RESISTANT TILE BACKER GYPSUM BOARD AS SPECIFIED.

					EA	EACH
•	ENERGY DESIGN NOTES		_	DEMOLITION NOTES	EF ELEC	EACH FACE ELECTRICAL
	 VALUES NOTED ARE REFERENCED FROM OBC SB-10 TABLE SB 5.5-6-2017, BUILDING ENVELOPE REQUIREMENTS FOR CLIMATE ZONE 6 (A, B) (I-P). ALL FENESTRATION AND ELEMENTS NOT VISIBLE IN PLAN VIEW ARE TO COMPLY WITH THE ABOVE NOTED TABLE. 	ASSEMBLY LEGEND W301.2 W301.2 SUBSTRATE TYPE	1. 2.	WITH ALL REMOVALS, CONTRACTOR TO MAKE GOOD ADJACENT REMAINING SURFACES, INCLUDING BUT NOT LIMITED TO, FLOORING BASE, WALLS, CEILING, MILLWORK & FIXTURES. IT IS THE SOLE RESPONSIBILITY OF THE CONTRACTOR TO DESIGN ALL SHORING AND TEMPORARY BRACING AS PER O.REG. 213/91 AND THE CONTRACTOR SHALL RETAIN AN ENGINEER AS REQUIRED.	ELEV ECC EFC EJ ELECT EMP ENCL EP	ELEVATION EPOXY CEILING COATING EPOXY FLOOR COATING EXPANSION JOINT ELECTRICAL EMERGENCY POWER ENCLOSED ELECTRICAL PANEL
-	CEILING PLAN LEGEND Image: Pot light, see elec. dwgs. Image: Directional pot light, see elec. dwgs. Image: Ceiling Mounted light fixture, see elec. dwgs. Image: Wall Mounted light fixture, see elec. dwgs. Image: Ceissed light fixture, see elec. dwgs.	SUFFIX ASSEMBLY: B BELOW GRADE C CEILING E EXTERIOR WALL F FLOOR R ROOF S SOFFIT W INTERIOR PARTITION SUBSTRATE: 1 CONCRETE	3. 4. 5.	DISPOSE OF REMOVED ITEMS IN A LAWFUL MANNER IN ACCORDANCE WITH THE MUNICIPALITY HAVING JURISDICTION'S RULES & REGULATIONS. ALL EXISTING WALLS TO REMAIN ARE SHOWN SHADED. ALL EXISTING WALLS AND ITEMS TO BE REMOVED ARE SHOWN DASHED OR AS KEYNOTED WITHIN PLANS. NOT ALL ITEMS WILL HAVE A KEYNOTE PROVIDED FOR CONVENIENCE. WHERE DASHED WALLS ARE SHOWN, IT IS ASSUMED THAT ALL SUB-ELEMENTS AND SYSTEMS WITHIN ARE TO BE DEMOLISHED & REMOVED, UNLESS NOTED OTHERWISE.	EP EQ EQUIP ES ESRI ETC EW EWC EXTG EXT F	ELECTRICAL PANEL EQUAL EQUIPMENT ELECTRICAL STRIKE ELECTRICAL STRIKE ROUGH IN ET CETERA EACH WAY EPOXY WALL COATING EXISTING EXTERIOR
Wxxx ? D1 (W1)	☑ EXHAUST FAN, SEE MECH. DWGS. ☑ SUPPLY AIR DIFFUSER, SEE MECH. DWGS. Ⅲ RETURN AIR GRILLE, SEE MECH. DWGS. Ⅱ LINEAR SUPPLY AIR DIFFUSER, SEE MECH. DWGS. □ FIRE SPRAY INSULATION AT U/S OF STRUCTURE □ DENOTES CEILING TYPE AND CEILING HEIGHT, SEE ASSEMBLY SCHEDULE	2 CONCRETE BLOCK MASONRY 3 STEEL FRAMING 4 WOOD FRAMING TYPE: VARIES (SEE DESCRIPTIONS) SUFFIX: 0 SMOKE SCREEN 1 1 HR FIRE RATING 2 2 HR FIRE RATING	6. 7. 8. 9.	OWNER TO HAVE RIGHT OF FIRST REFUSAL FOR ALL ITEMS REMOVED. ALL REMOVED ITEMS SHALL BE DISPOSED IN ACCORDANCE TO NOTE #3. COORDINATE WITH STRUCTURAL, MECHANICAL, & ELECTRICAL DRAWINGS FOR ALL RELATED COMPONENTS OF DEMOLITION, MODIFICATION, & PROPOSED WORK. REMOVE AND/OR RELOCATE ALL MECHANICAL & ELECTRICAL SERVICES/CONNECTIONS AS REQUIRED TO ACCOMMODATE DEMOLITION, OR AS A RESULT OF DEMOLITION. ENSURE ALL FLOOR ARAES ARE FREE OF HAZARDS DURING & AFTER DEMOLITION. LEVEL, PATCH, & GRIND	FAP FCRD FD FDC FE FEC FHC FIN FJ FL FLASH FND	FIRE ALARM PANEL FLOW CONTROL ROOF DRAIN FLOOR DRAIN FIRE DEPARTMENT CONNECTION FIRE EXTINGUISHER FIRE EXTINGUISHER CABINET FIRE HOSE CABINET FINISH FLOOR JOIST FLOOR FLASHING FOUNDATION
CLG 2750 PT-1	CEILING PLAN NOTES 1. ALL LIGHT FIXTURES ARE TO BE CENTRED WITHIN ROOM UNLESS NOTED OTHERWISE.	3 3 HR FIRE RATING 7 30 MINUTE FIRE RATING 8 45 MINUTE FIRE RATING 9 90 MINUTE FIRE RATING ASSEMBLY NOTES	10.	FLOOR AS REQUIRED TO CREATE SMOOTH SURFACE READY TO RECEIVE FINISHED FLOORING. ALL EXTERIOR OPENINGS CREATED BY DEMOLITION ARE TO BE HOARDED AND SECURELY FASTENED WITH 16mm PLYWOOD SUPPORTED ALL SIDES.	FND FRR FS ft ² G	FOUNDATION FIRE RESISTANCE RATING FIRE SEPARATION SQUARE FEET
	 ALL CEILINGS ARE GYPSUM BOARD UNLESS NOTED OTHERWISE. AREAS THAT ARE NOT DENOTED WITH A CEILING TAG NOR HATCHING ARE TO BE LEFT EXPOSED UNLESS NOTED OTHERWISE. REFER TO ELECTRICAL DRAWINGS FOR FULL SCOPE OF ELECTRICAL DEVICES AND SPECIFICATIONS. NOTIFY THE ARCHITECT OF ANY FOUND DISCREPANCIES AND/OR CONFLICTS. REFER TO MECHANICAL DRAWINGS FOR FULL SCOPE OF MECHANICAL DEVICES AND SPECIFICATIONS. NOTIFY THE 	 REFER TO GENERAL NOTES FOR ADDITIONAL INFORMATION. GYPSUM BOARD FOR RATED ASSEMBLIES SHALL BE IN CONFORMANCE WITH APPLICABLE UNDERWRITERS' LABORATORIES OF CANADA DESIGN, REFER TO ASSEMBLIES FOR DESIGNATION WHERE APPLICABLE. ALL FIRE STOPPING OF SERVICE PENETRATIONS SHALL BE INSTALLED IN CONFORMANCE WITH OBC ARTICLE 3.1.9.1. 	11. 12. 13.	HORIZONTAL EXTERIOR OPENINGS CREATED BY DEMOLITION ARE TO BE FURTHER PROTECTED WITH WEATHERTIGHT MEMBRANES. MAINTAIN CLEAN, SAFE, & ORDERLY SITE AT ALL TIMES. SHOULD MATERIAL RESEMBLING SPRAY/TROWEL APPLIED ASBESTOS OR OTHER TOXIC/HAZARDOUS MATERIALS BE ENCOUNTERED DURING DEMOLITION, STOP WORK, TAKE PREVENTITIVE MEASURES & NOTIFY ARCHITECT AND/OR OWNER IMMEDIATELY. DO NOT PROCEED WITHOUT WRITTEN INSTRUCTIONS.	GA GALV GB GC GL GRAN GWB GWG GYP H	GAUGE GALVANIZED GRAB BAR GENERAL CONTRACTOR GLAZING GRANULAR GYPSUM WALL BOARD GEORGIAN WIRE GLASS GYPSUM
Name Elevation	 ARCHITECT OF ANY FOUND DISCREPANCIES AND/OR CONFLICTS. EXTENT OF SPRINKLER SYSTEM NOT SHOWN. GENERAL CONTRACTOR TO SUPPLY AND INSTALL SPRINKLER SYSTEM TO APPLICABLE CODES TO SUIT PLANS. GENERAL CONTRACTOR TO SUPPLY SHOP DRAWINGS FOR SPRINKLER SYSTEM PRIOR TO INSTALLATION TO THE ARCHITECT FOR REVIEW AND APPROVAL. LIGHT FIXTURES AND MECHANICAL DUCTWORK/ DIFFUSERS/ RETURN AIR GRILLES/ EQUIPMENT SHOWN 	 SUPPLY AND INSTALL GYPSUM BOARD CONTROL JOINTS IN WALLS EXCEEDING 9 METRES IN LENGTH SPACED AT A MAXIMUM OF 9 METRES o/c. INSTALL CONTROL JOINTS AS PER MANUFACTURERS INSTALLATION INSTRUCTIONS. ALL STEEL STUDS TO BE DESIGNED BY DRYWALL CONTRACTORS ENGINEERS; STAMPED SHOP DRAWINGS TO BE PROVIDED TO CONSULTANTS FOR REVIEW. REFER TO ROOM FINISH SCHEDULE FOR FINISHES. 	1. 2. 3.	DOOR AND FRAME SUPPLIER (HOLLOW METAL & ALUMINUM) SHALL PROVIDE ALL REQUIRED CLOSURE TRIMS FOR ALL EXTERIOR FRAMES TO SUIT CORRESPONDING OPENINGS. PROVIDE WEATHERSTRIPPING TO ALL EXTERIOR DOORS. PROVIDE SEALANT AROUND ALL EXTERIOR HOLLOW	HB HD HEF HIF HL HM HOF HORIZ HP	HOSE BIB HAND DRYER HORIZONTAL EACH FACE HORIZONTAL INSIDE FACE HOT LAID (ASPHALT) HOLLOW METAL HORIZONTAL OUTSIDE FACE HORIZONTAL HIGH POINT
1 / A101 NE ER CE ER	FOR COORDINATION ONLY. NOT ALL FIXTURES ARE SHOWN. REFER TO MECHANICAL AND ELECTRICAL DRAWINGS FOR MORE INFORMATION/ QUANTITY/ MOUNTING HEIGHTS/ ETC.	DEMOLITION LEGEND	6.	METAL AND ALUMINUM DOOR FRAMES ON EXTERIOR AND INTERIOR SIDES. SEALANT COLOUR TO MATCH FRAMES. RATED INTERIOR HOLLOW METAL FRAMES TO BE FILLED SOLID WITH MORTAR. EXTERIOR HOLLOW METAL DOORS TO HAVE REINFORCED CORES TO PREVENT WARPING. SHIM CLOSERS ON EXTERIOR DOORS TO PREVENT	HR HRL HSS HT HTR HYD	HOUR HAND RAIL HOLLOW STRUCTURAL STEEL HEIGHT HEATER HYDRANT
	DENOTES DOOR & SWING D1 EXISTING WALL TO REMAIN	EXISTING WALL TO REMAIN EXISTING WALL TO BE DEMOLISHED KEYNOTE DENOTING THAT ALL RELATED ITEMS WITHIN ROOM ARE TO BE DEMOLISHED	7. 8. 9.	CUTTING OF WEATHERSTRIPPING. ALL FIRE RATED DOORS TO HAVE POSITIVE LATCHING MECHANISM HARDWARE IN ACCORDANCE WITH OBC 3.1.8.13. FILL EXTERIOR HOLLOW METAL FRAMES & ALUMINUM FRAMING WITH FOAMED-IN-PLACE INSULATION. ALUMINUM DOOR HARDWARE TO BE SUPPLIED AND INSTALLED BY ALUMINUM FRAME CONTRACTOR.	IIC ID IF IHM INCL INSUL INT IRWB	INCLUDED IN CONTRACT INSIDE DIMENSION INSIDE FACE INSULATED HOLLOW METAL INCLUDED INSULATION INTERIOR IMPACT RESISTANT WALL BOARD

ABBREVIATIONS:

		J	
	AT AIR BARRIER	JAN JT	JANITOR JOINT
	AIR CONDITIONING ACRYLIC STUCCO FINISH ACOUSTIC CEILING TILE	K KP	KICKPLATE
	ACCESS FLOOR ABOVE FINISHED FLOOR	KCT	KITCHEN CEILING TILE
1	ASPHALT IMPREGNATED FIBRE BOARD ALUMINUM ANODIZED	L	LAMINATE
NOX	ANOULLU ANNUNCIATOR PANEL APPROXIMATE	LAV LCK	LAVATORY LOCKER(S)
1	ARCHITECTURAL AUDITORIUM	LSG LTWT	LAMINATED SAFETY GLASS LIGHT WEIGHT
	AIR / VAPOUR BARRIER AUDIO / VISUAL	lp M	LOW POINT
		m² MAG	SQUARE METERS MAGNETIC LOCK
1	BEAM BY FLOOR MANUFACTURER BOARD BOTTOM EACH WAY	MANUF MAX	MANUFACTURED MAXIMUM
	BARRIER FREE BUMPER GUARD	MAT MDF	MATERIAL MEDIUM DENSITY FIBRE BOARD MECHANICAL
ì	BUILDING BLOCK	MECH MED MEMB	MECHANICAL MEDIUM MEMBRANE
	BOTTOM LOWER LAYER BENCH MARK	MEZZ MHO	MEZZANINE MAGNETIC HOLD OPEN
-	BASE PLATE BRICK BASEMENT	MIN MISC	MINIMUM MISCELLANEOUS
	BASEMENT BENT STEEL PLATE BOTTOM	ML MO MT	MAGNETIC LOCK MASONRY OPENING METAL
	BETWEEN STEEL BUILT UP (TO OWSJ)	MTD	MOUNTED
	BOTTOM UPPER LAYER	N NBC	NATIONAL BUILDING CODE
	CLEAN ANODIZED	NIC NFHB	NOT IN CONTRACT NON FREEZE HOSE BIB
	CATCH BASIN CEMENT BOARD	No NTS	NUMBER NOT TO SCALE
	CENTER TO CENTER CORNER GUARD CAST-IN-PLACE	0	
	CONSTRUCTION JOINT CENTER LINE	OBC o/c OD	ONTARIO BUILDING CODE ON CENTER OUTSIDE DIMENSION
	CEILING COLOUR	OF OFFC	OUTSIDE DIMENSION OUTSIDE FACE OFFICE
	CLOSET COMPOSITE METAL PANEL	OH OPSD	OVERHEAD ONTARIO PROVINCIAL STANDARD DETAIL
ST -	COLUMN CONSTRUCTION	OPSS OS	ONTARIO PROVINCIAL STANDARD SPECIFICATION OVERFLOW SCUPPER
C RD	CONTINUOUS CONCRETE COORDINATE	OSB OWSJ	ORIENTED STRAND BOARD OPEN WEB STEEL JOIST
	CARPET CARD READER	P PDO	POWER DOOR OPERATOR
	COURSE CURTAIN TRACK	PED P.LAM	PEDESTAL PLASTIC LAMINATE
	COMPLETE WITH CERAMIC WALL TILE	PLYWD PNT	PLYWOOD PAINT(ED)
	DEGREE	POLY PREFIN	POLYETHENE PREFINISHED
	DRINKING FOUNTAIN DIAMETER	PT PTD R	PRESSURE TREATED PAPER TOWEL DISPENSER
	DIAMETER DIMENSION	R&D	REMOVE AND DISPOSE
	DIVISION DOWN	R&R RA	REMOVE AND REINSTATE ROOF ANCHOR
	DEMOUNTABLE PARTITION DOOR SEAL DOOR SWEEP	RAD RCP RD	RADIUS REFLECTED CEILING PLAN ROOF DRAIN
	DETAIL DISHWASHER	REINF REQ'D	REINFORCED REQUIRED
(S)	DRAWING(S)	RFE RHC	RECESSED FIRE EXTINGUISHER RECESSED HEATING CABINET
	EACH	RJ RM	ROOF JOIST ROOM
	EACH FACE ELECTRICAL ELEVATION	ro Rtu Rwl	ROUGH OPENING ROOF TOP UNIT RAIN WATER LEADER
	EPOXY CEILING COATING EPOXY FLOOR COATING	S	
т	EXPANSION JOINT ELECTRICAL	SC SHT	SAWCUT SHEET
	EMERGENCY POWER ENCLOSED	SIM SPEC SPF	SIMILAR SPECIFICATION SPRUCE PINE FIR
Р	ELECTRICAL PANEL EQUAL EQUIPMENT	SF SF SND	SQUARE FOOT SANITARY NAPKIN DISPOSAL
	ELECTRICAL STRIKE ELECTRICAL STRIKE ROUGH IN	SOG SS	SLAB-ON-GRADE STAINLESS STEEL
	ET CETERA EACH WAY	STFP STL	STEPPED FOOTING STEEL
ì	EPOXY WALL COATING EXISTING	STM STOR	STORM STORAGE
	EXTERIOR	SUSP SWRD	STRUCTURAL SUSPENDED SIDE WALL ROOF DRAIN
)	FIRE ALARM PANEL FLOW CONTROL ROOF DRAIN	T	
	FLOOR DRAIN FIRE DEPARTMENT CONNECTION	TB TBAL	THERMALLY BROKEN THERMALLY BROKEN ALUMINUM
	FIRE EXTINGUISHER FIRE EXTINGUISHER CABINET FIRE HOSE CABINET	TBHM TEMP TH	THERMALLY BROKEN HOLLOW METAL TEMPERED THICK
	FIRE HOSE CABINET FINISH FLOOR JOIST	TJ TLL	TIE JOIST TOP LOWER LAYER
Н	FLOOR FLASHING	T/O TUL	TOP OF TOP UPPER LAYER
	FOUNDATION FIRE RESISTANCE RATING	typ U	TYPICAL
	FIRE SEPARATION SQUARE FEET	U/G ULC	UNDERGROUND UNDERWRITERS LABORATORIES OF CANADA
	GALIGE	ULC UNO UR	UNDERWRITERS LABORATORIES OF CANADA UNLESS NOTED OTHERWISE URINAL
1	GAUGE GALVANIZED GRAB BAR	U/S	UNDERSIDE OF
	GENERAL CONTRACTOR GLAZING	V VB	VAPOUR BARRIER
1	GRANULAR GYPSUM WALL BOARD	VCT VEST	VINYL COMPOSITE TILE VESTIBULE
	GEORGIAN WIRE GLASS GYPSUM	VERT VEF	VERTICAL VERTICAL EACH FACE
	HOSE BIB	VI VIF VOF	VINYL VERTICAL INSIDE FACE VERTICAL OUTSIDE FACE
	HOSE BIB HAND DRYER HORIZONTAL EACH FACE	W	
	HORIZONTAL INSIDE FACE HOT LAID (ASPHALT)	W WC	WIDE WATER CLOSET
7	HOLLOW METAL HORIZONTAL OUTSIDE FACE	WD WR	WOOD WASTE RECEPTACLE
Z	HORIZONTAL HIGH POINT HOUR	WFE WV	WALL MOUNTED FIRE EXTINGUISHER WATER VALVE
	HOUR HAND RAIL HOLLOW STRUCTURAL STEEL	WWM W/D w/o	WELDED WIRE MESS WASHER/DRYER WITHOUT
	HEIGHT HEATER	w/o W/R w/	WITHOUT WASHROOM WITH
	HYDRANT	X	
	INCLUDED IN CONTRACT	XTR	EXISTING TO REMAIN
	INSIDE DIMENSION INSIDE FACE		

BUILDING PERMIT

7	Mar 14/25	Issued for Building Permit
6	Dec 03/24	Issued for Budget Costing
No.	DATE	ISSUE



1404 Doon Village Road, Kitchener On, N2P 1A5 PROJECT 1404 Doon Village Oasis

1404 Doon Village Road, Kitchener On, N2P 1A5 DRAWING

General Notes

PROJECT No.	
24-008	
PROJECT DATE	
September 23, 2024	A00 ⁻
DRAWN BY	
zschickler	




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12 Water Service/Rughy is Adaquety Image: Service/Rughy is Adaqu	10	Standpipe	Required:			🗆 Ye	S	☑ No		3.2.9.					
13 High Building Image:	11	Fire Alarm	Required:			🗆 Ye	S	✓ No		3.2.4.	9.10.17.2.				
4 Printing Construction:	12	Water Serv	vice / Supply is Adequat	te:		☑ Ye	S	🗆 No		3.2.5.7.	N/A				
	13	High Buildi	ing:			🗆 Ye	S	No No		3.2.6.	N/A				
10 OctupantLoad: Im Pi person Val Design of Building Doctupancy: Laad: Nortice Norticoritice Norticoritice No	14									3.2.2.62.	9.10.6.				
Por Level Space: Cocupany: Lad:: I Reside remain Image: Im	15	Mezzanine	e(s) Area (m ²):							3.2.1.1.(3-8)	9.10.4.1.				
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17 Barnerine Design: Ves No Sa. 9.52. Building Permitting 18 Heardrow Substances: Ves Ves		Existing to	Remain			Το	al:								
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Spatial separation - Construction of Exterior Walls: Spatial separation - Construction Spatial separation - Constructi					(N/A)					1					
Wails Area of EBF (m ²) L.D. (m) L/H Hatto U.O.s (%) F.H.H. (Hours) or Description Construction Non Cladding Construction 20 North Image: Construction of Description Non Cladding Construction Non Cladding Construction 20 North Image: Construction of Description Non Cladding Construction Non Cladding Construction 20 North Image: Construction of Description Non Cladding Construction Non Cladding Construction 20 North Image: Construction of Description Non Cladding Construction Non Cladding Construction 20 West Image: Construction of Description Image: Construction of Description of Description Image: Construction of Description Image: Construction of Description Non Cladding 21 Other: Image: Construction of Description of Description of Description of Description of Description Image: Construction of Description of Description of Description of Description Non Cladding Construction		Spatial Sep	paration - Construction	of Exterior Walls:		D		1							
20 North North Image: Constraint of the second of the seco			Area of EBF (m ²)	L.D. (m)	L/H Ratio		U.O.s (%)	F.R.R. (Hours)	Listed Design or Description						ARCHITECTURE INC
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21 Other:															
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	Spatial Separation Calculations (Table 9.10.15.4)									
Wall	Area of Exposed Building Face (m ²)	Limiting Distance (m)	Permitted Glazed Openings (%)	Proposed Glazed Openings (%)	Proposed Glazed Openings (m ²)	Comb/Non Co Constructio				
North										
	83.1 m ²	21.7 m	< 100%	43.57%	36.21 m ²	Yes				
South										
	93.08 m²	9.5 m	84%	8.69%	8.10 m ²	Yes				
East										
E1	68.04 m ²	3.01 m	18%	10%	6.875 m ²	Yes				
West										
W1	49.763 m ²	8.4 m	< 100%	78.9%	39.26 m ²	Yes				
W2	18.45 m²	7.2 m	< 100%	42.3%	7.8 m ²	Yes				



Comb ion	Comb/Non Comb Cladding	

	Ene	rgy Efficiency De	si	gn Sumn	nary		
1	Project Location	on	Kit	chener			
2	Heating Degre	e Days:	420	00 HDD (SB-1)			
3	ASHRAE Clim	ate Zone:	Zo	ne 6			
4	OBC SB-12			Energy Efficiency Requirements in Conformance with SB-12 3.1.1.11(3)			
	BUILDING CO	MPONENT		IAX. U-VALUE			
	Building Does	Not Use Electric Space Heating:	יי	IAX. U-VALUE	MIN. R-VALUE		
5	Doors, Window	vs and Walls	1.4		R 4.0		
6	Roofs and Sky	lights	2.6		R 2.2		
	Building Uses	Electric Space Heating:					
7	Doors, Window	vs and Walls	1.2		R 4.7		
8	Roofs and Sky	lights	2.6		R 2.2		
9	Area of Windo	ws, Skylights & Glass (W, S & G)			•		
	Elevation	Area of Wall (m ²)		Area of W	V, S & G (m²)		
	North	89.682		33.715			
	South	42.740	35.327				
	East	102.299	11.819				
	West	120.993		53.511			
	Total	355.714		134.372			

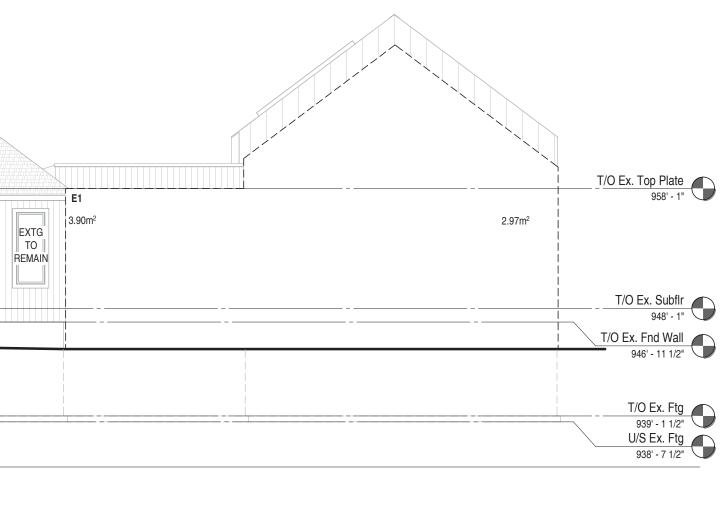


OWNER

1404 Doon Village Road, Kitchener On, N2P 1A5 PROJECT 1404 Doon Village Oasis

1404 Doon Village Road, Kitchener On, N2P 1A5

Code Compliance Matrix

PROJECT No.	
24-008	
PROJECT DATE	
September 23, 2024	A002
DRAWN BY	
zschickler	

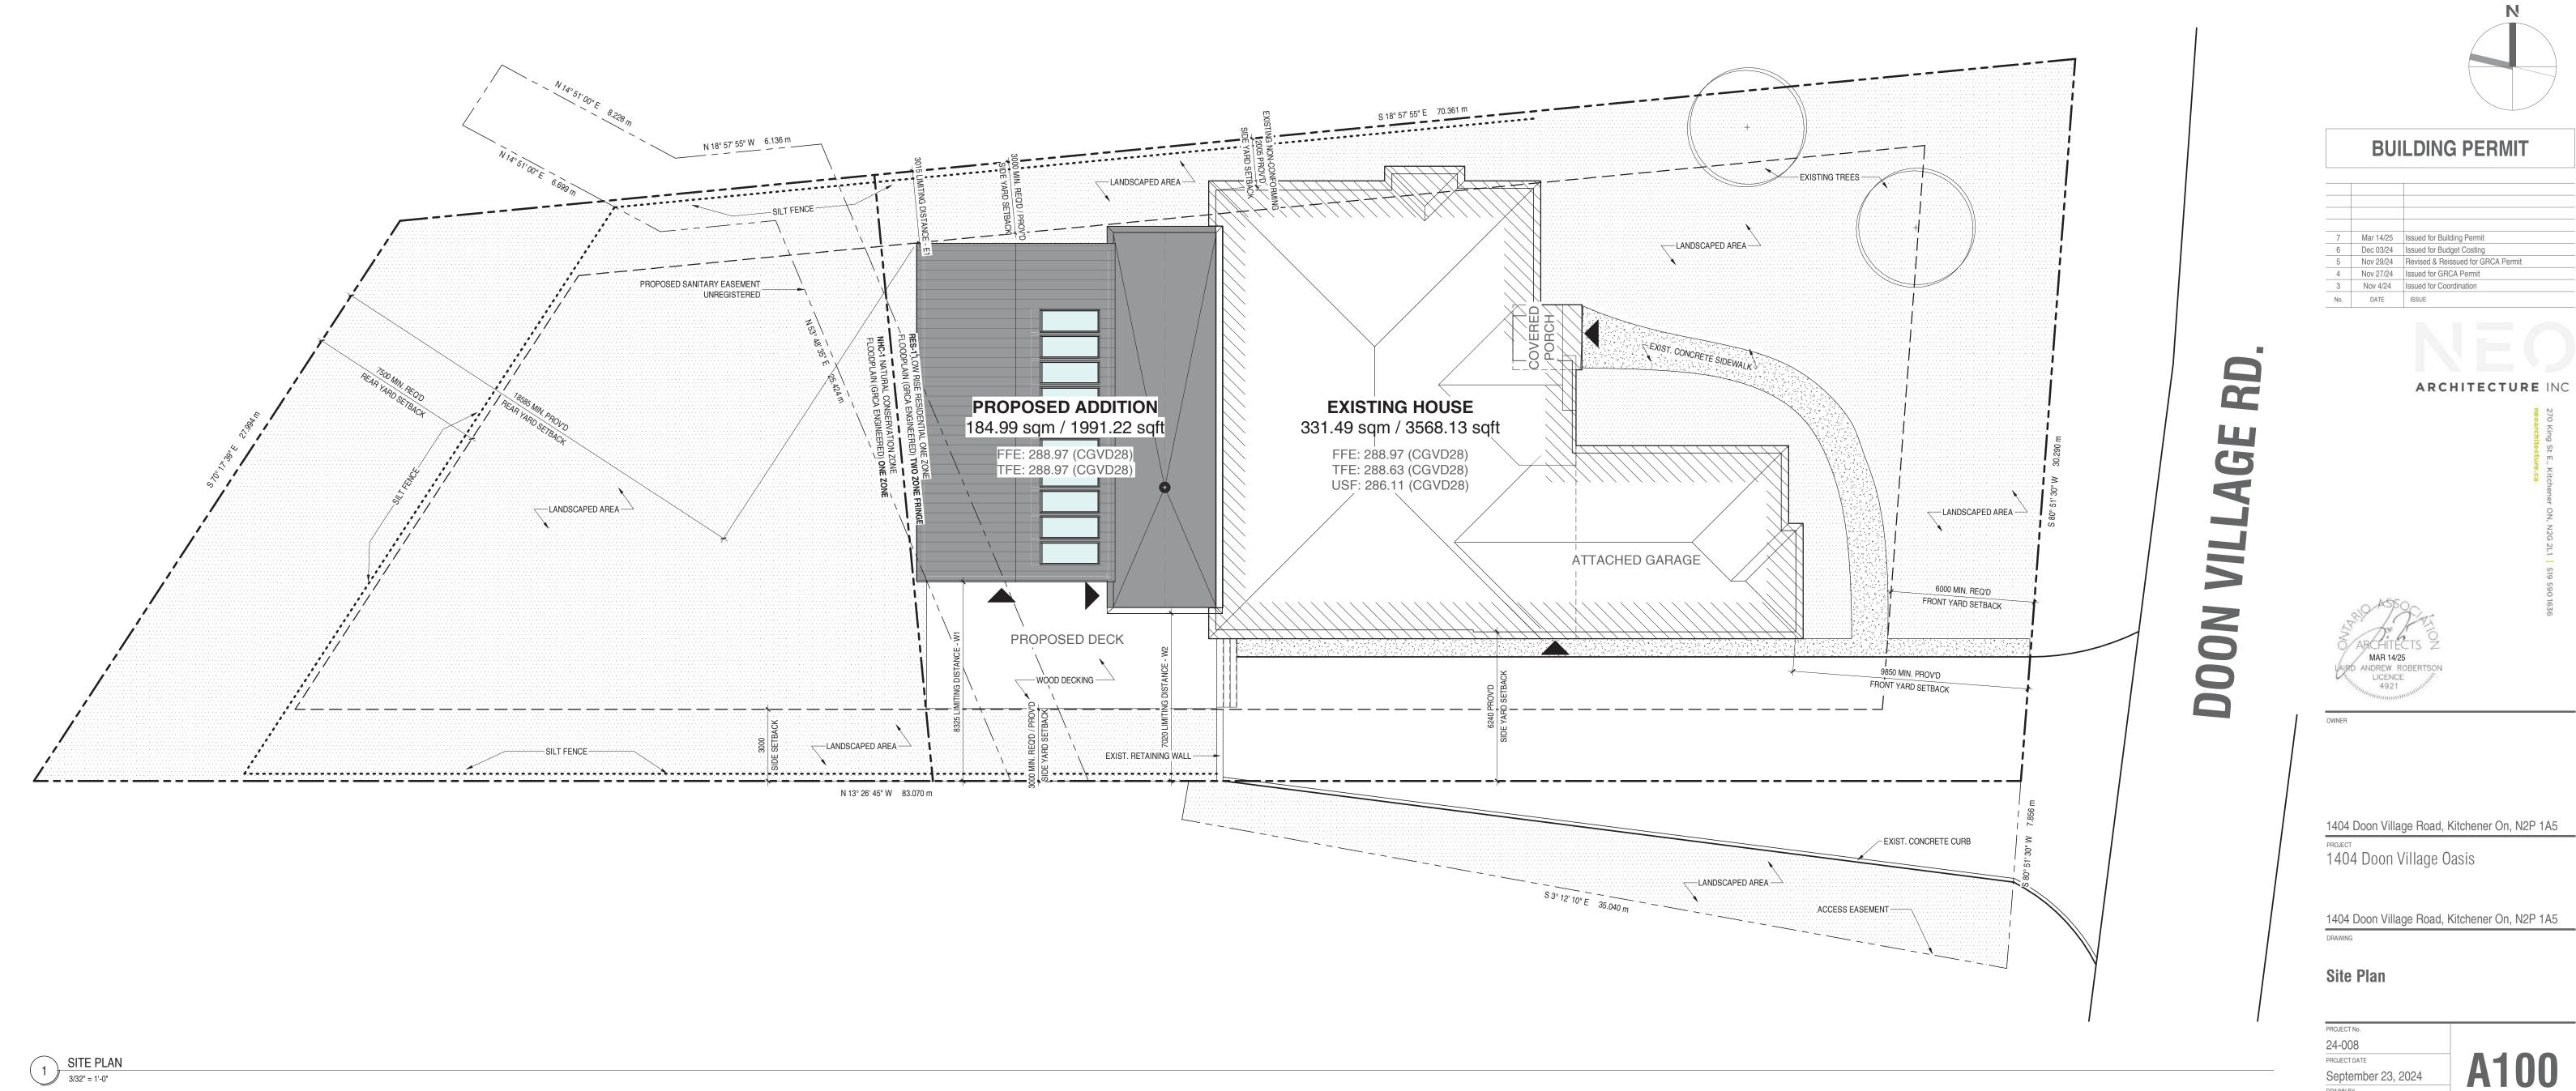


2019-051	City of Kitchener Zoning By-Law Required		Proposed		Variance		
	ZONING	RES-1 (262), (267)	NHC	RES-1 (262), (267)	NHC	RES-1 (262), (267)	NHC
7.2 (Table 7-1)	PERMITTED USES	Single-Detached Dwelling	Natural Heritage Conservation	Single-Detached Dwelling	Natural Heritage Conservation	Single-Detached Dwelling	Natural Heritage Conservation
(262) b)	Minimum Lot Area	2023m ²		2023.45m ²			
(267)	Minimum Lot Width	29.5m		30.29m			
7.3 (Table 7-3)	Minimum Front Yard or Exterior Yard Setback	6.0m (3)		9.85m			
	Maximum Front Yard Setback	(3)		N/A			
	Minimum Interior Side Yard Setback	3.0m		3.0m			
	Minimum Rear Yard Setback	7.5m		18.59m			
	Maximum Lot Coverage	55% (4)		40%			
	Maximum Building Height	11.0m (6)		10.0m			
	Maximum number of <i>storeys</i>	3		1			
5.6 (Table 5-5)	Minimum parking spaces:	1 per dwelling unit (1)		3 per dwelling unit (3)			

1404 DOON VILLAGE RD. KITCHENER St. DOON VILLAGE RD.

September 23, 2024

zschickler

RFE: 288.10 (CGVD28)

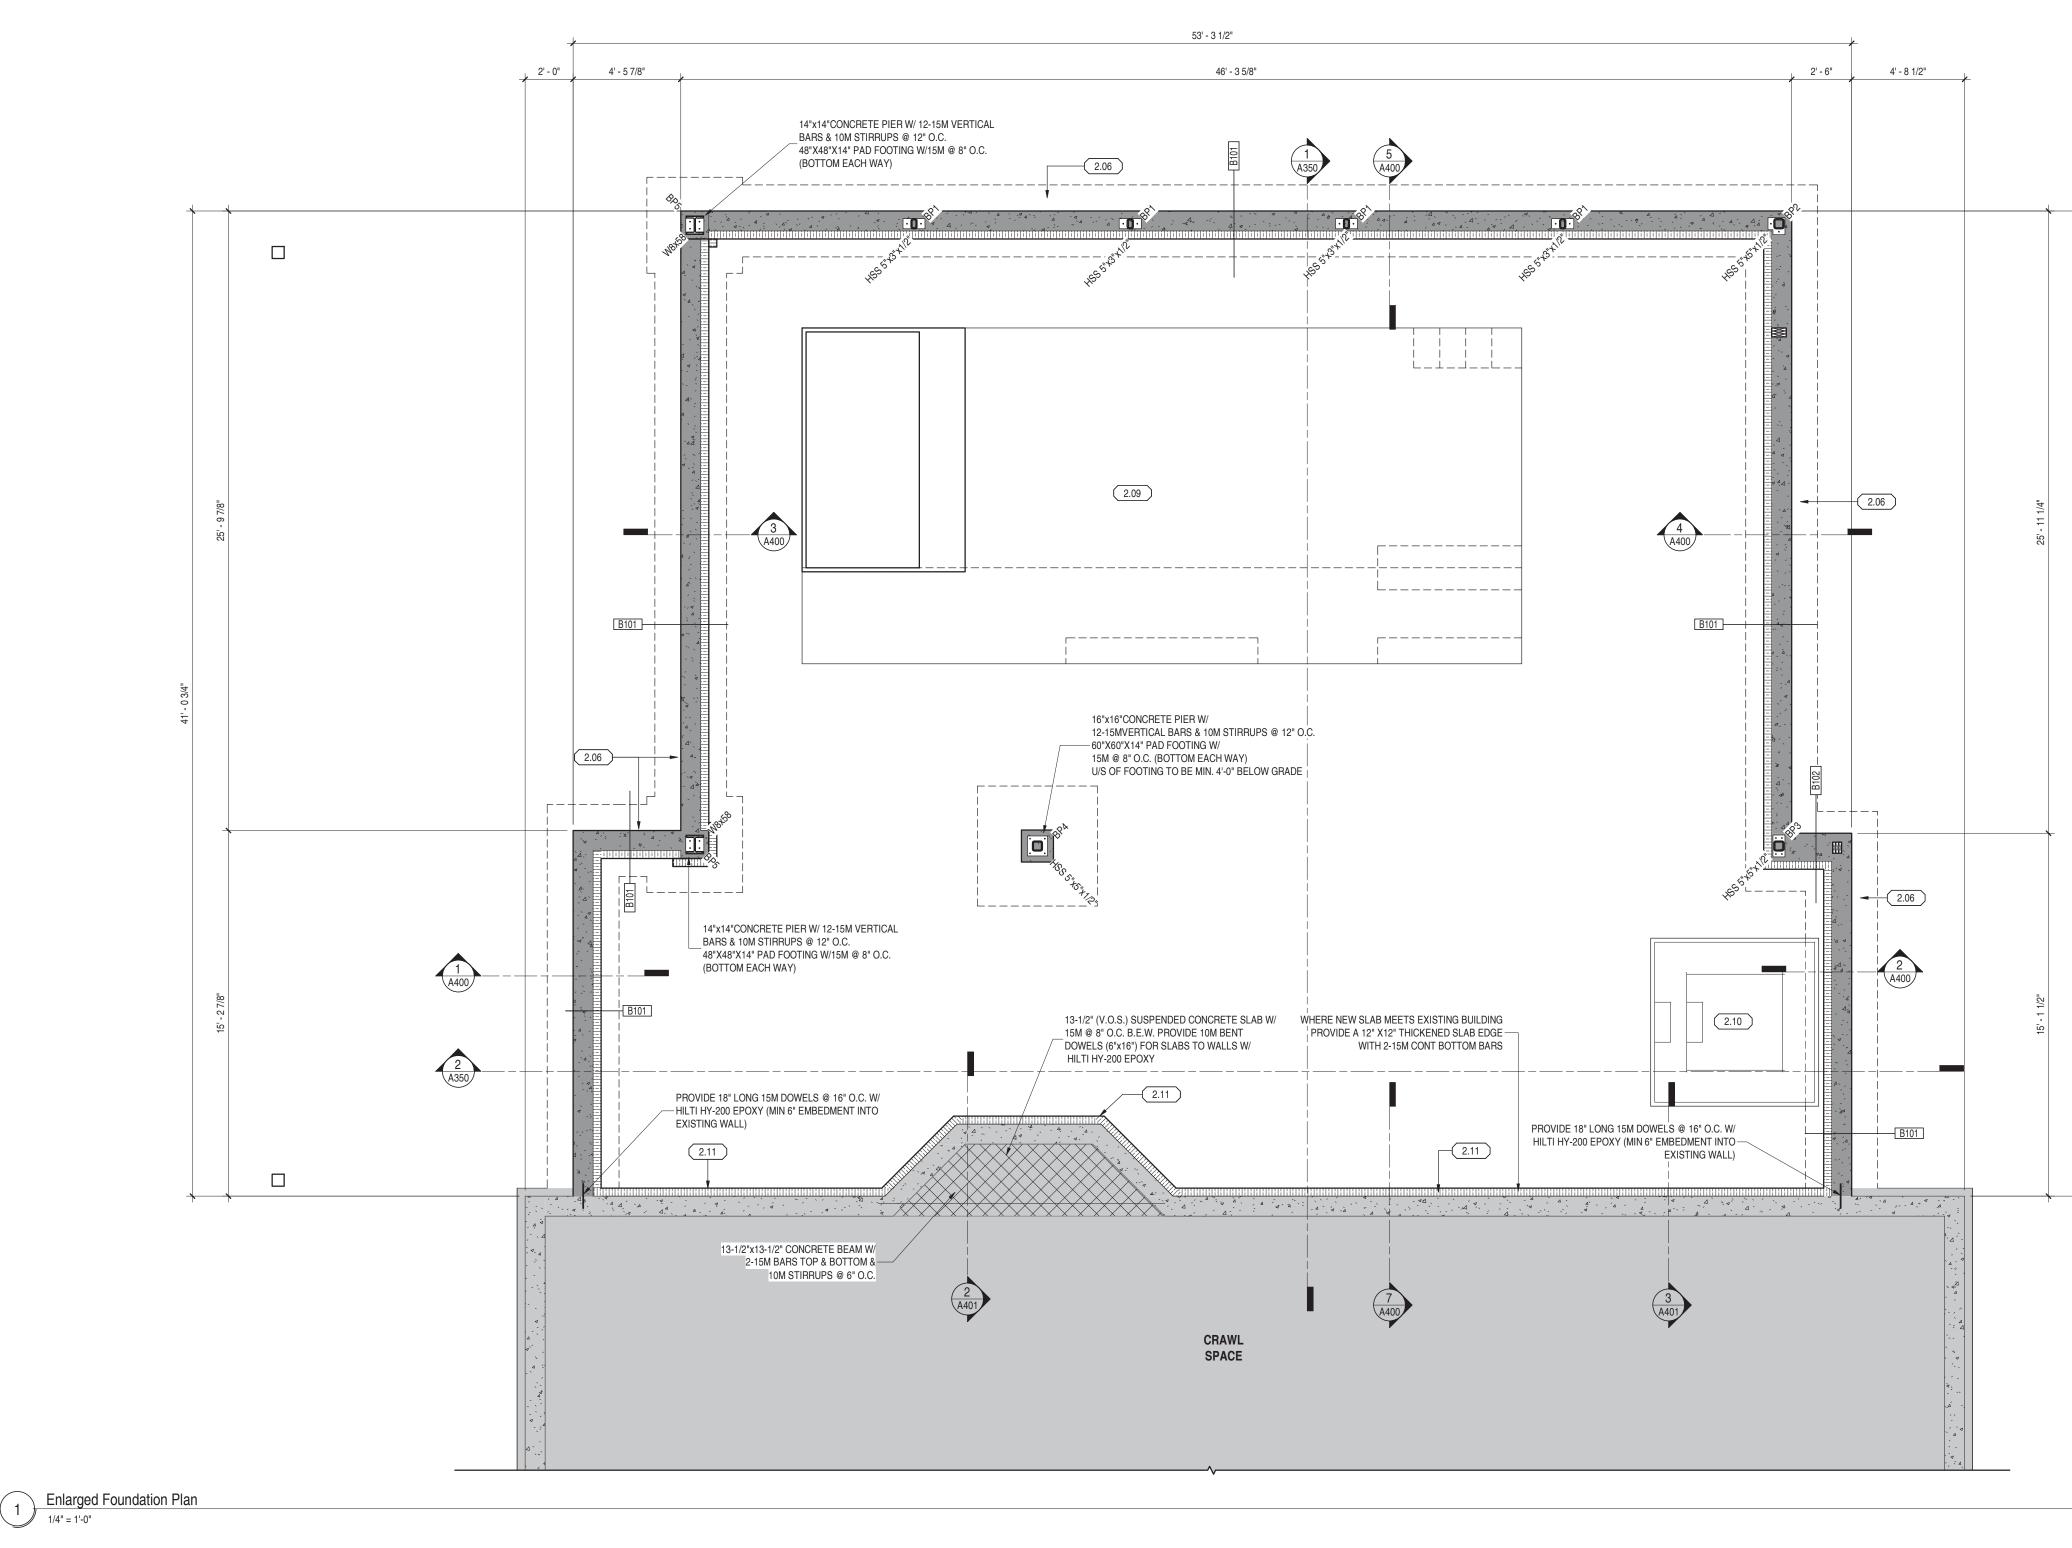



BAS	EPLATE SCHEDULE
	BP-1 - 11"x 5"x1/2" BASEPLATE W/ (2)-1/2" DIA. THREADED RODS + HILTI HY-200 EPOXY (MIN. 6" EMBED.)
⁸ 1/2" ¹ ¹ ¹ ¹ ²	BP-2 - 8 1/2"x6"x1/2" L-BASEPLATE W/ (2)-1/2" DIA THREADED RODS + HILTI HY-200 EPOXY (MIN. 6" EMBED.)
	BP-3 - 11"x 6"x1/2" BASEPLATE W/ (4)-1/2" DIA. THREADED RODS + HILTI HY-200 EPOXY (MIN. 6" EMBED.)
	BP-4 - 10"x 10"x1/2" BASEPLATE W/ (4)-1/2" DIA. THREADED RODS + HILTI HY-200 EPOXY (MIN. 6" EMBED.)
	BP-5 - 9 1/2"x 9"x1/2" BASEPLATE W/ (4)-1/2" DIA. THREADED RODS + HILTI HY-200 EPOXY (MIN. 6" EMBED.)

KEYNOTE LEGEND

2.06 10"x36" STRIP FOOTING

- 2.09 PREFABRICATED FIBERGLASS POOL INSERT C/W PLUMBING & SYSTEMS AS REQUIRED, POOL FOUNDATIONS (IF REQUIRED) BY OTHERS (MANUFACTURER: LATHAM POOLS) (MODEL: PROVIDENCE 14) OR APPROVED ALTERNATIVE
- 2.10 PREFINISHED IN-GROUND HOT-TUB SYSTEM C/W PLUMBING & SYSTEMS AS REQUIRED, HOT-TUB FOUNDATIONS (IF REQUIRED) BY OTHERS
- 2.11 2" RIGID INSULATION TO BE INSTALLED ON THE EXTERIOR FACE OF EXISTING FOUNDATION WALL.

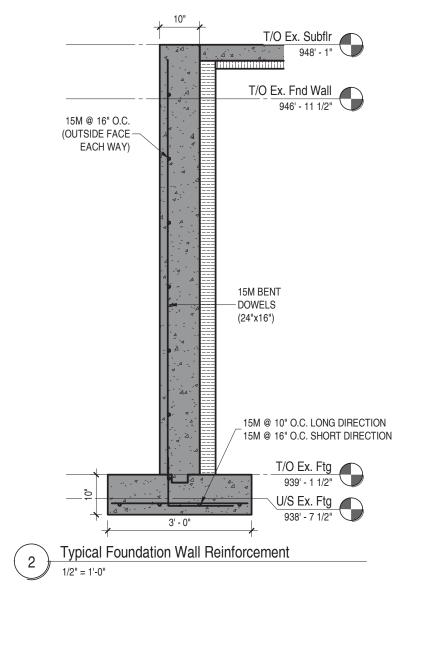

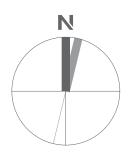

BUILDING PERMIT

7	Mar 14/25	Issued for Building Permit
6	Dec 03/24	Issued for Budget Costing
3	Nov 4/24	Issued for Coordination
2	Oct 22/24	Issued for Coordination
No.	DATE	ISSUE






-REVIEWED & SEALED FOR STRUCTURAL INFORMATION ONLY. -ANY FOUNDATION REQUIREMENTS FOR THE POOL/HOT TUB ARE BY OTHERS. -REFER TO S1.0 FOR STRUCTURAL NOTES

1404 Doon Village Road, Kitchener On, N2P 1A5 PROJECT 1404 Doon Village Oasis

1404 Doon Village Road, Kitchener On, N2P 1A5

Foundation Plan




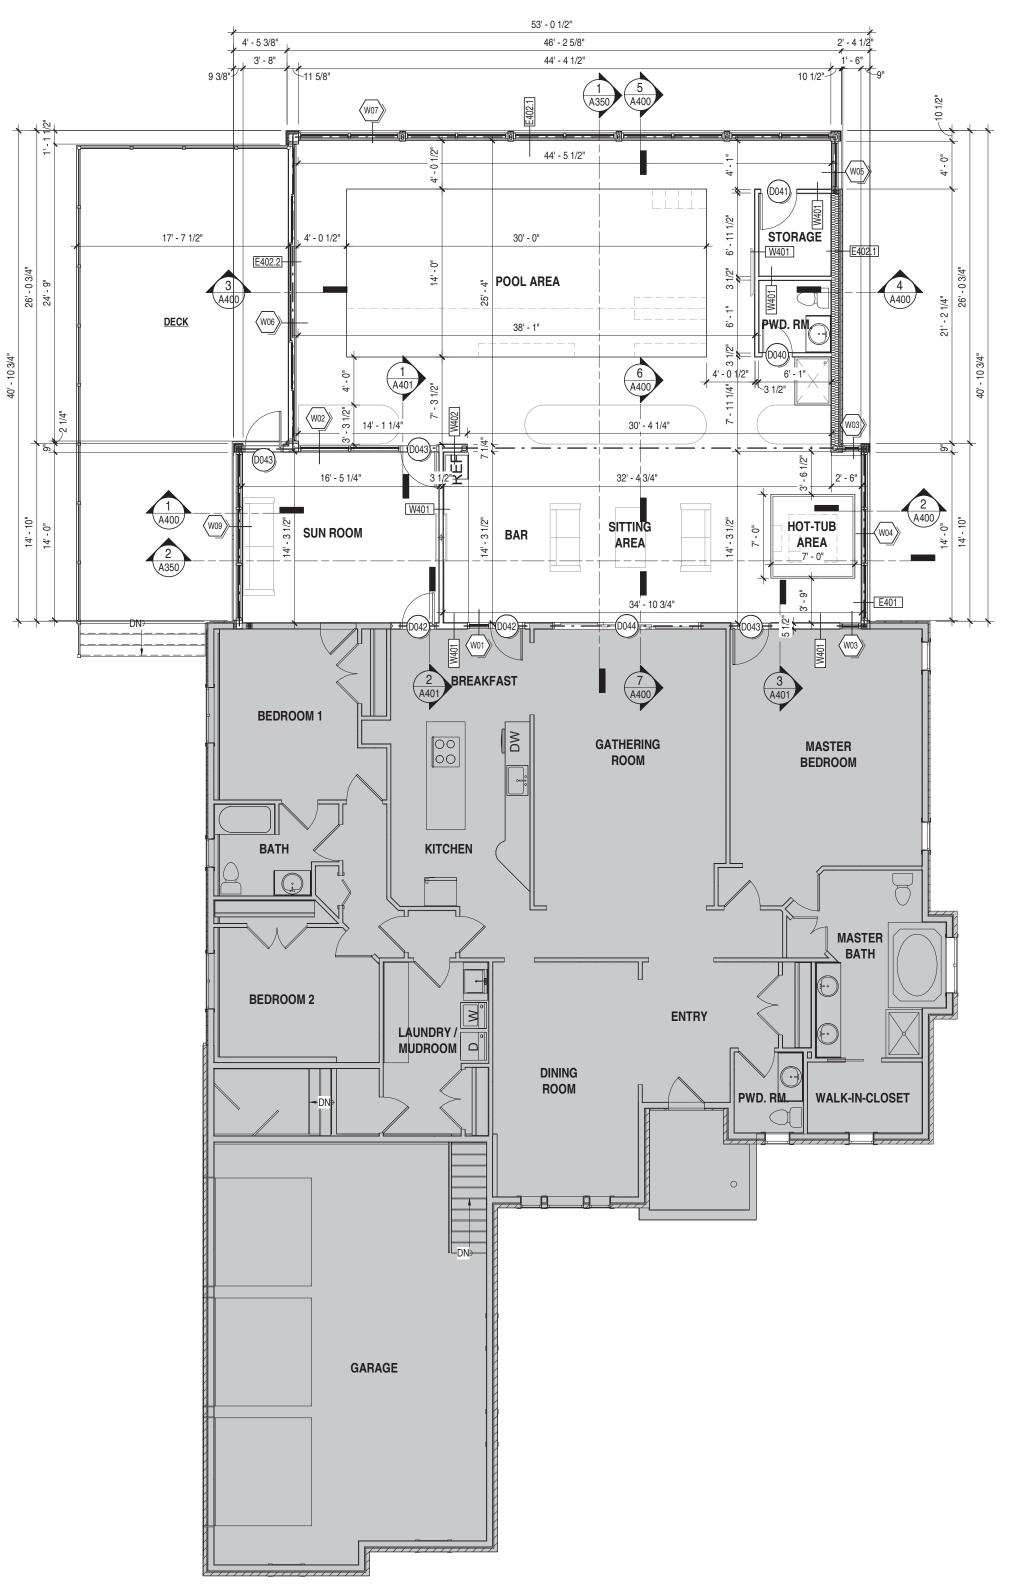

2 Proposed Ground Floor Plan 1/8" = 1'-0"

PLAN V	IEW LEGEND
	- DENOTES DOOR & SWING
	EXISTING WALL TO REMAIN

KEYNOTE LEGEND

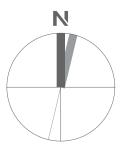

BUILDING PERMIT

_	14/05	
7	Mar 14/25	Issued for Building Permit
6	Dec 03/24	Issued for Budget Costing
3	Nov 4/24	Issued for Coordination
2	Oct 22/24	Issued for Coordination
1	Sept 27/24	Issued for Coordination
No.	DATE	ISSUE




1404 Doon Village Road, Kitchener On, N2P 1A5 PROJECT 1404 Doon Village Oasis

1404 Doon Village Road, Kitchener On, N2P 1A5

Proposed Ground Floor Plan

ROJECT No.	
4-008	
ROJECT DATE	Δ201
September 23, 2024	AZUI
RAWN BY	
schickler	

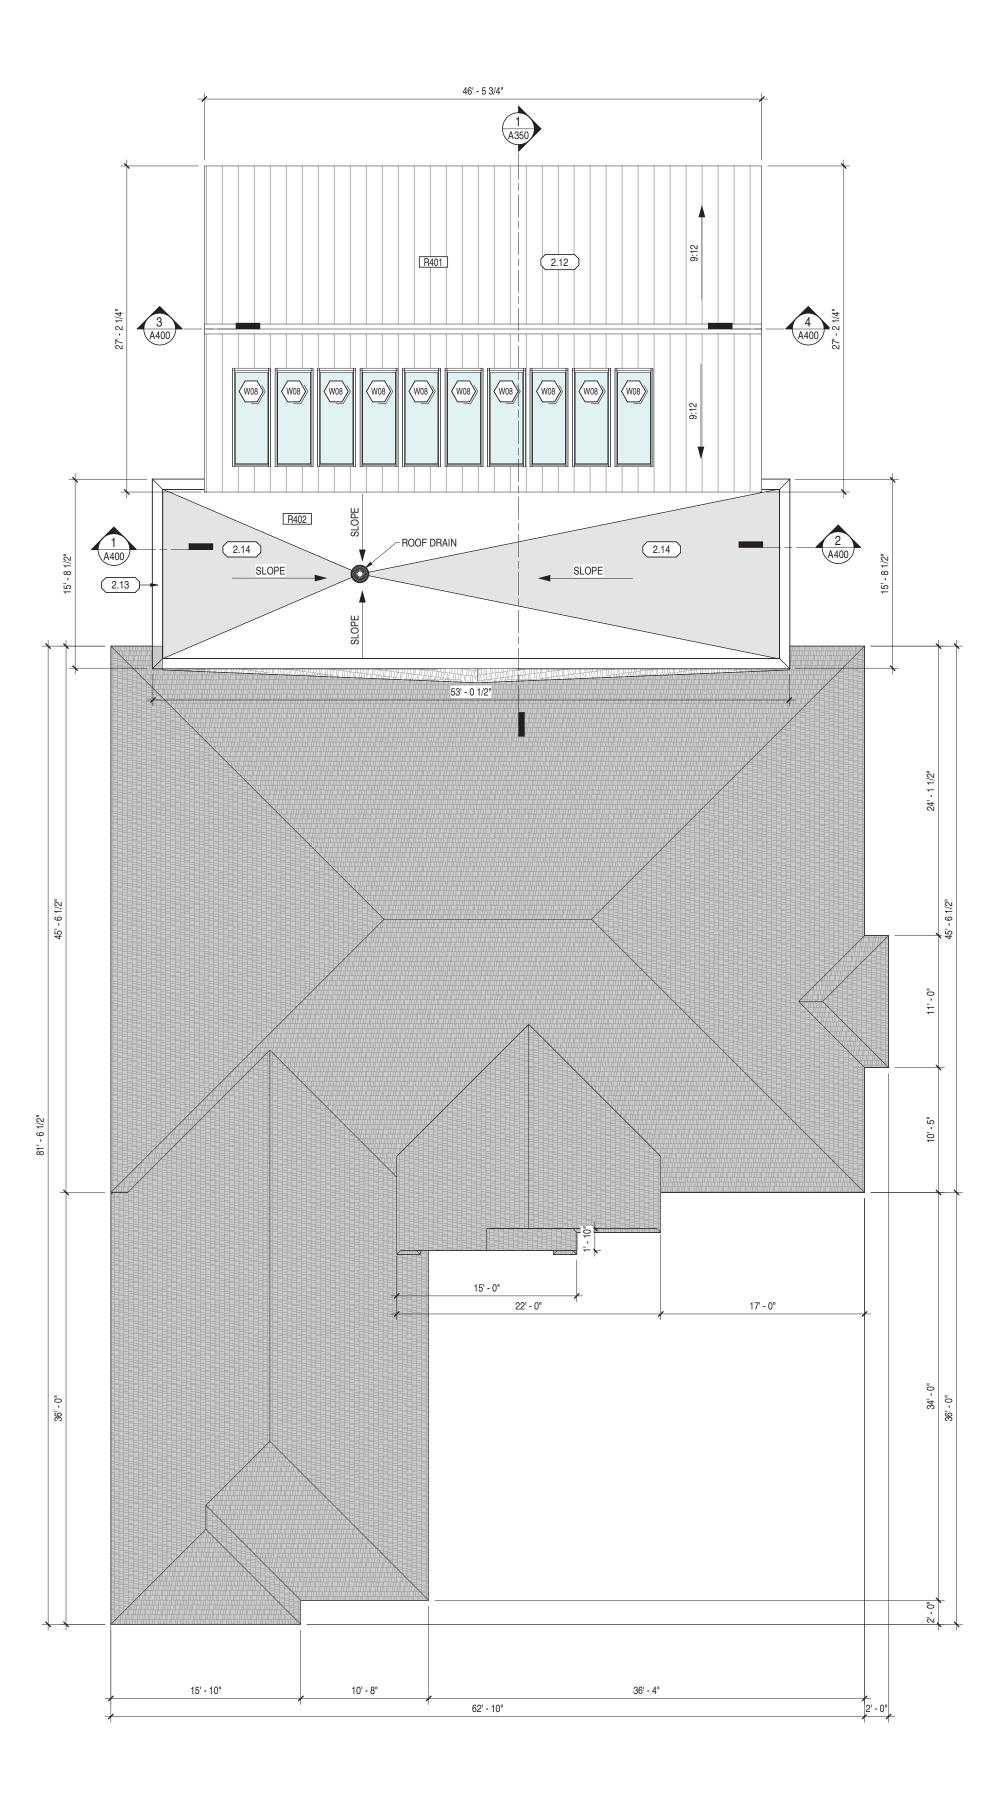

1 ROOF PLAN 1/8" = 1'-0"

PLAN VIEW LEGEND


DENOTES DOOR & SWING

EXISTING WALL TO REMAIN

KEYNOTE LEGEND

- 2.12 PREFINISHED VERTICAL METAL ROOF (MANUFACTURER: TBD/ STYLE: TBD/ COLOUR: LIGHT GREY)
 2.13 PREFINISHED BENT METAL FLASHING
 2.14 EXTENT OF CROSS-SLOPE FRAMING (SHOWN SHADED)

D1

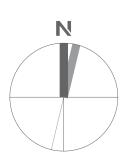

BUILDING PERMIT

7	Mar 14/25	Issued for Building Permit
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1	Sept 27/24	Issued for Coordination
No.	DATE	ISSUE




1404 Doon Village Road, Kitchener On, N2P 1A5 PROJECT 1404 Doon Village Oasis

1404 Doon Village Road, Kitchener On, N2P 1A5

Roof Plan

PROJECT No.	
24-008	
PROJECT DATE	
September 23, 2024	A203
DRAWN BY	
zschickler	

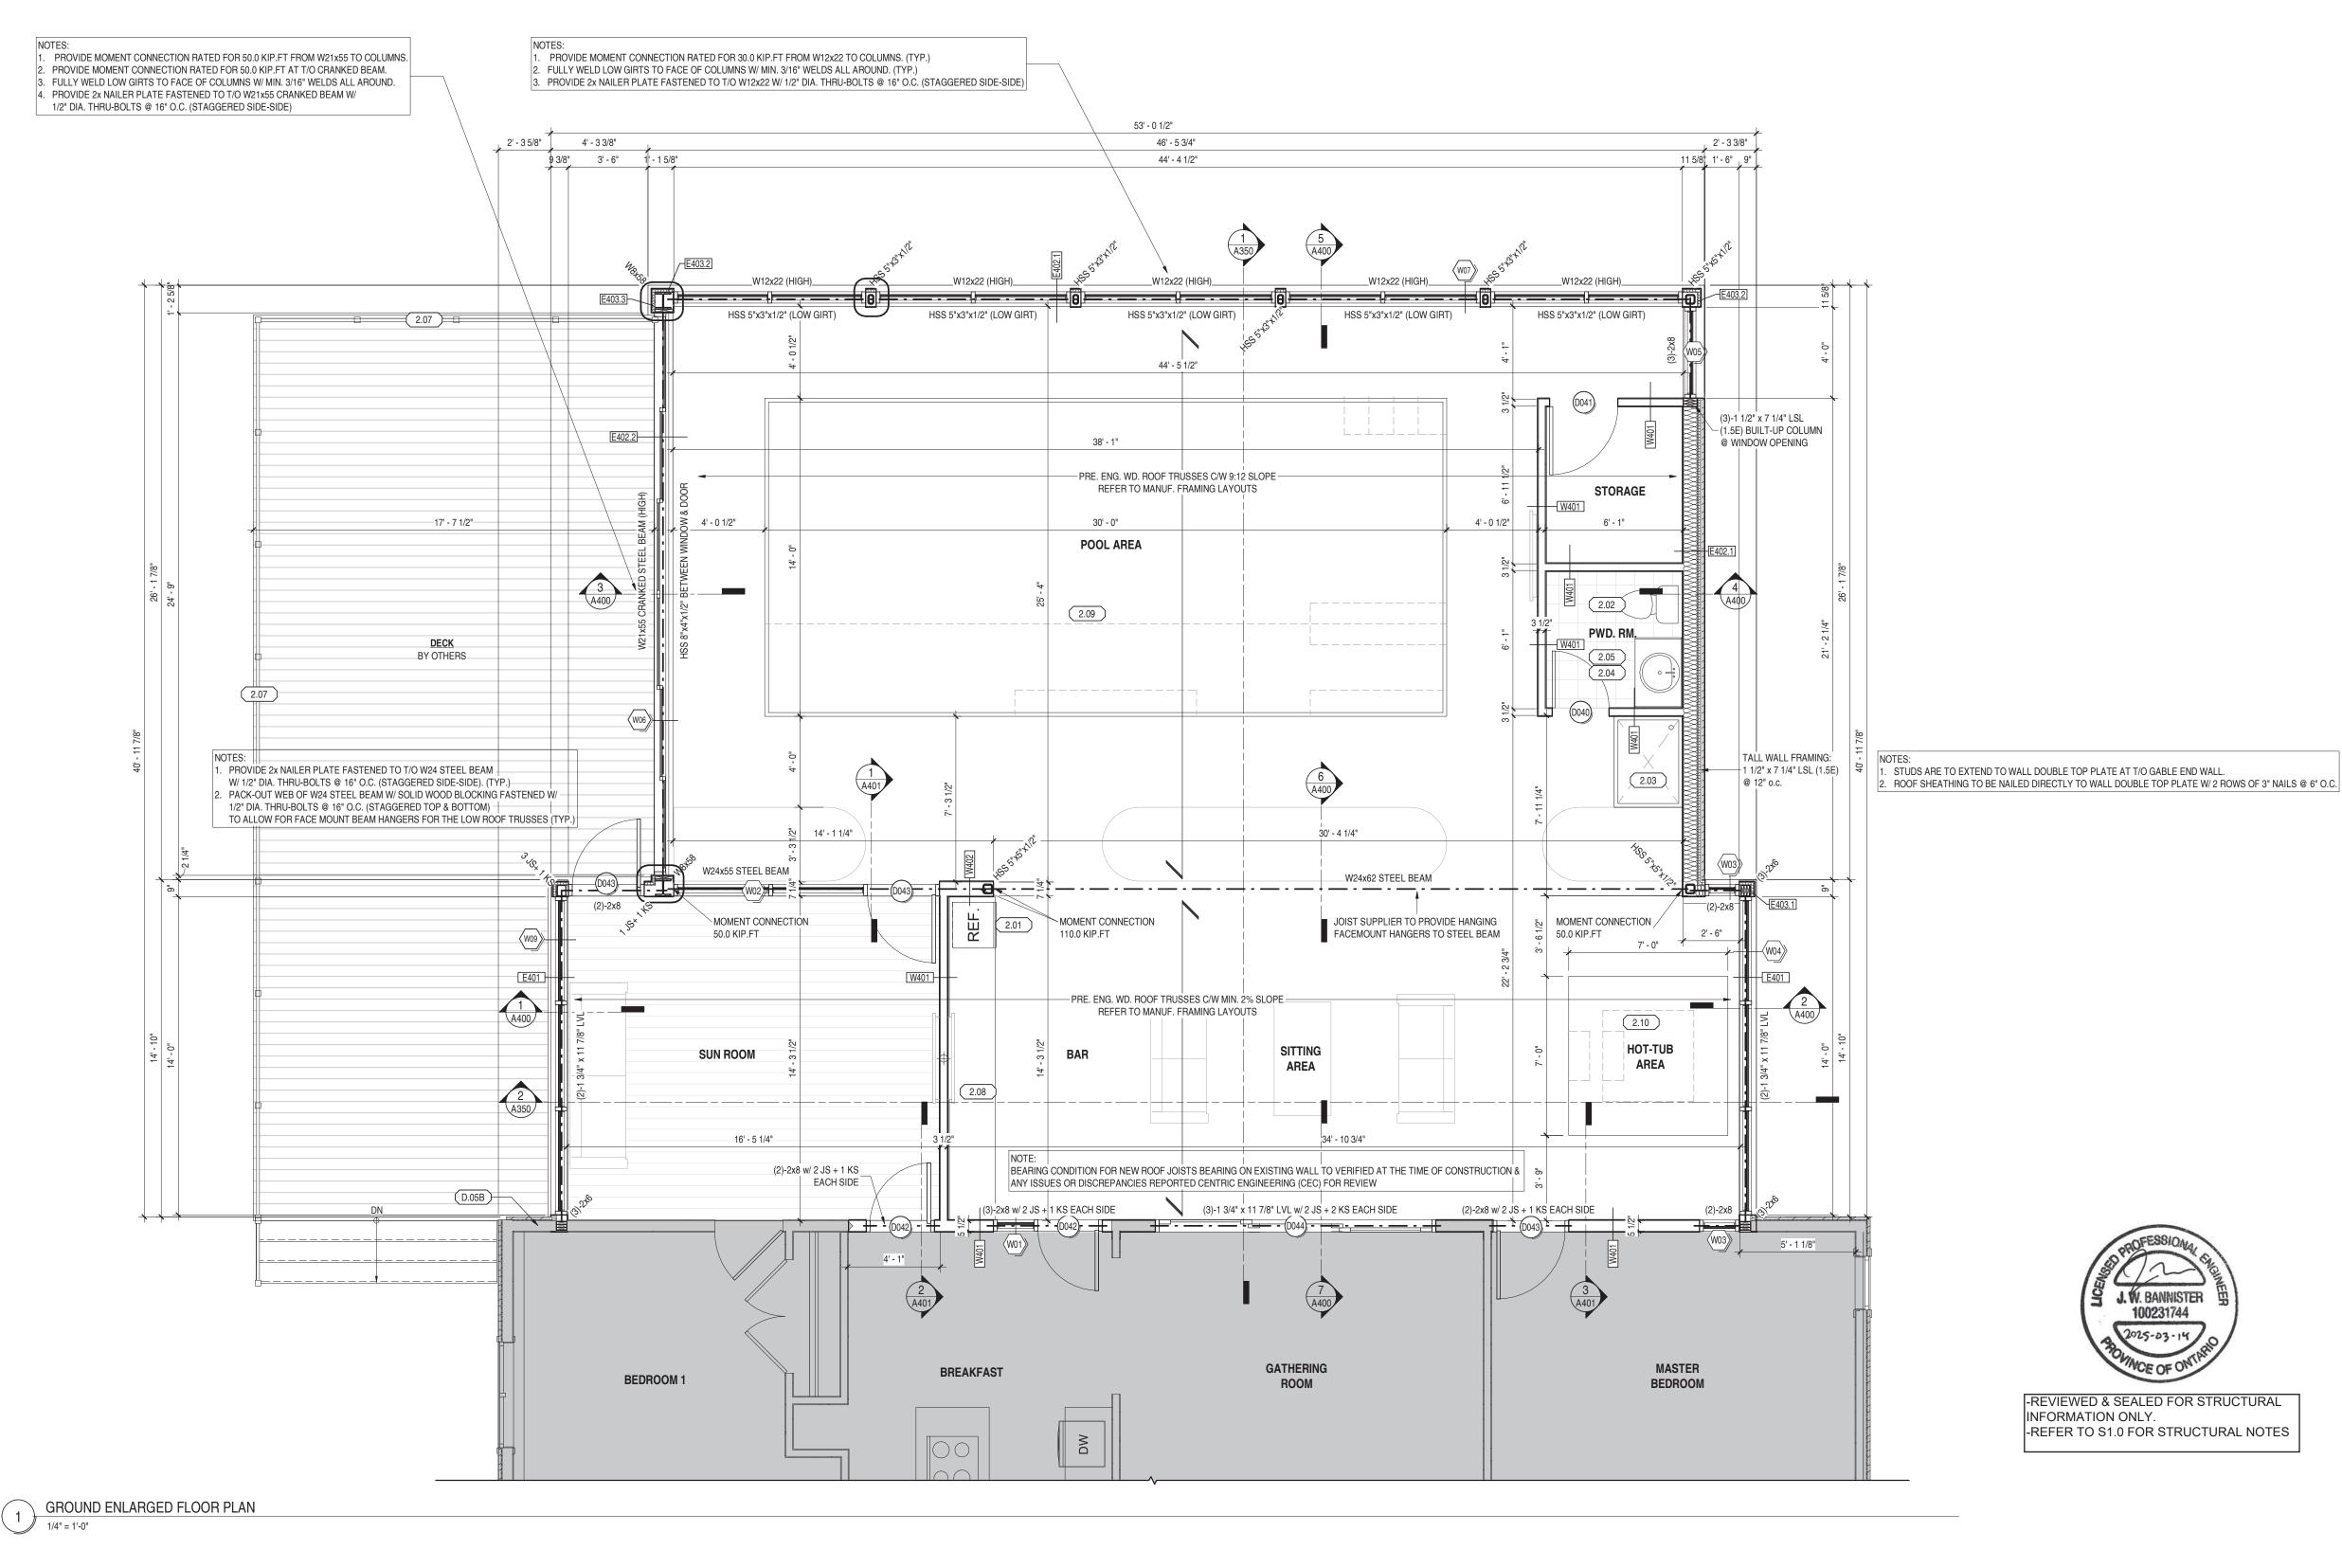


PLAN VIEW LEGEND

EXISTING WALL TO REMAIN

KEYNOTE LEGEND

- 2.01 BAR REFRIGERATOR, CONTRACTOR TO COORDINATE
- INSTALLATION. 2.02 WATER CLOSET, REFER TO MECH. DWGS.
- 2.03 WALK-IN ACRYLIC SHOWER BASE C/W SHOWER HEAD & CONTROLS, REFER TO MECH. DWGS. 2.04 VANITY C/W SINK BASIN & FAUCET, REFER TO MECH.
- DWGS. PROVIDE BLOCKING IN WALLS AS REQUIRED FOR FASTENING OF VANITY. CONTRACTOR TO COORDINATE ON SITE. 2.05 SUPPLY & INSTALL BATHROOM MIRROR & TOILET PAPER
- HOLDER PROVIDE SOLID BLOCKING AS REQUIRED FOR FASTENING. 2.07 GUARDRAIL TO 42" A.F.F. U.N.O. PROVIDE HANDRAILS AS
- SHOWN ON STAIR PLANS & SECTIONS. REFER TO ELEVATIONS FOR DETAILS. 2.08 COUNTERTOP
- 2.09 PREFABRICATED FIBERGLASS POOL INSERT C/W PLUMBING & SYSTEMS AS REQUIRED, POOL FOUNDATIONS (IF REQUIRED) BY OTHERS (MANUFACTURER: LATHAM POOLS) (MODEL: PROVIDENCE 14) OR APPROVED ALTERNATIVE
- 2.10 PREFINISHED IN-GROUND HOT-TUB SYSTEM C/W PLUMBING & SYSTEMS AS REQUIRED, HOT-TUB FOUNDATIONS (IF REQUIRED) BY OTHERS
- D.05B SIDING & SHEATHING TO BE ADDED TO EXISTING STUD (MATCH COLOUR TO EXISTING SIDING)

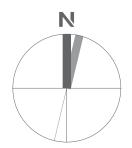

BUILDING PERMIT

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No.	DATE	ISSUE



1404 Doon Village Road, Kitchener On, N2P 1A5 PROJECT 1404 Doon Village Oasis

1404 Doon Village Road, Kitchener On, N2P 1A5 DRAWING


Enlarged Floor Plans





INFORMATION ONLY. -REFER TO S1.0 FOR STRUCTURAL NOTES

-REVIEWED & SEALED FOR STRUCTURAL

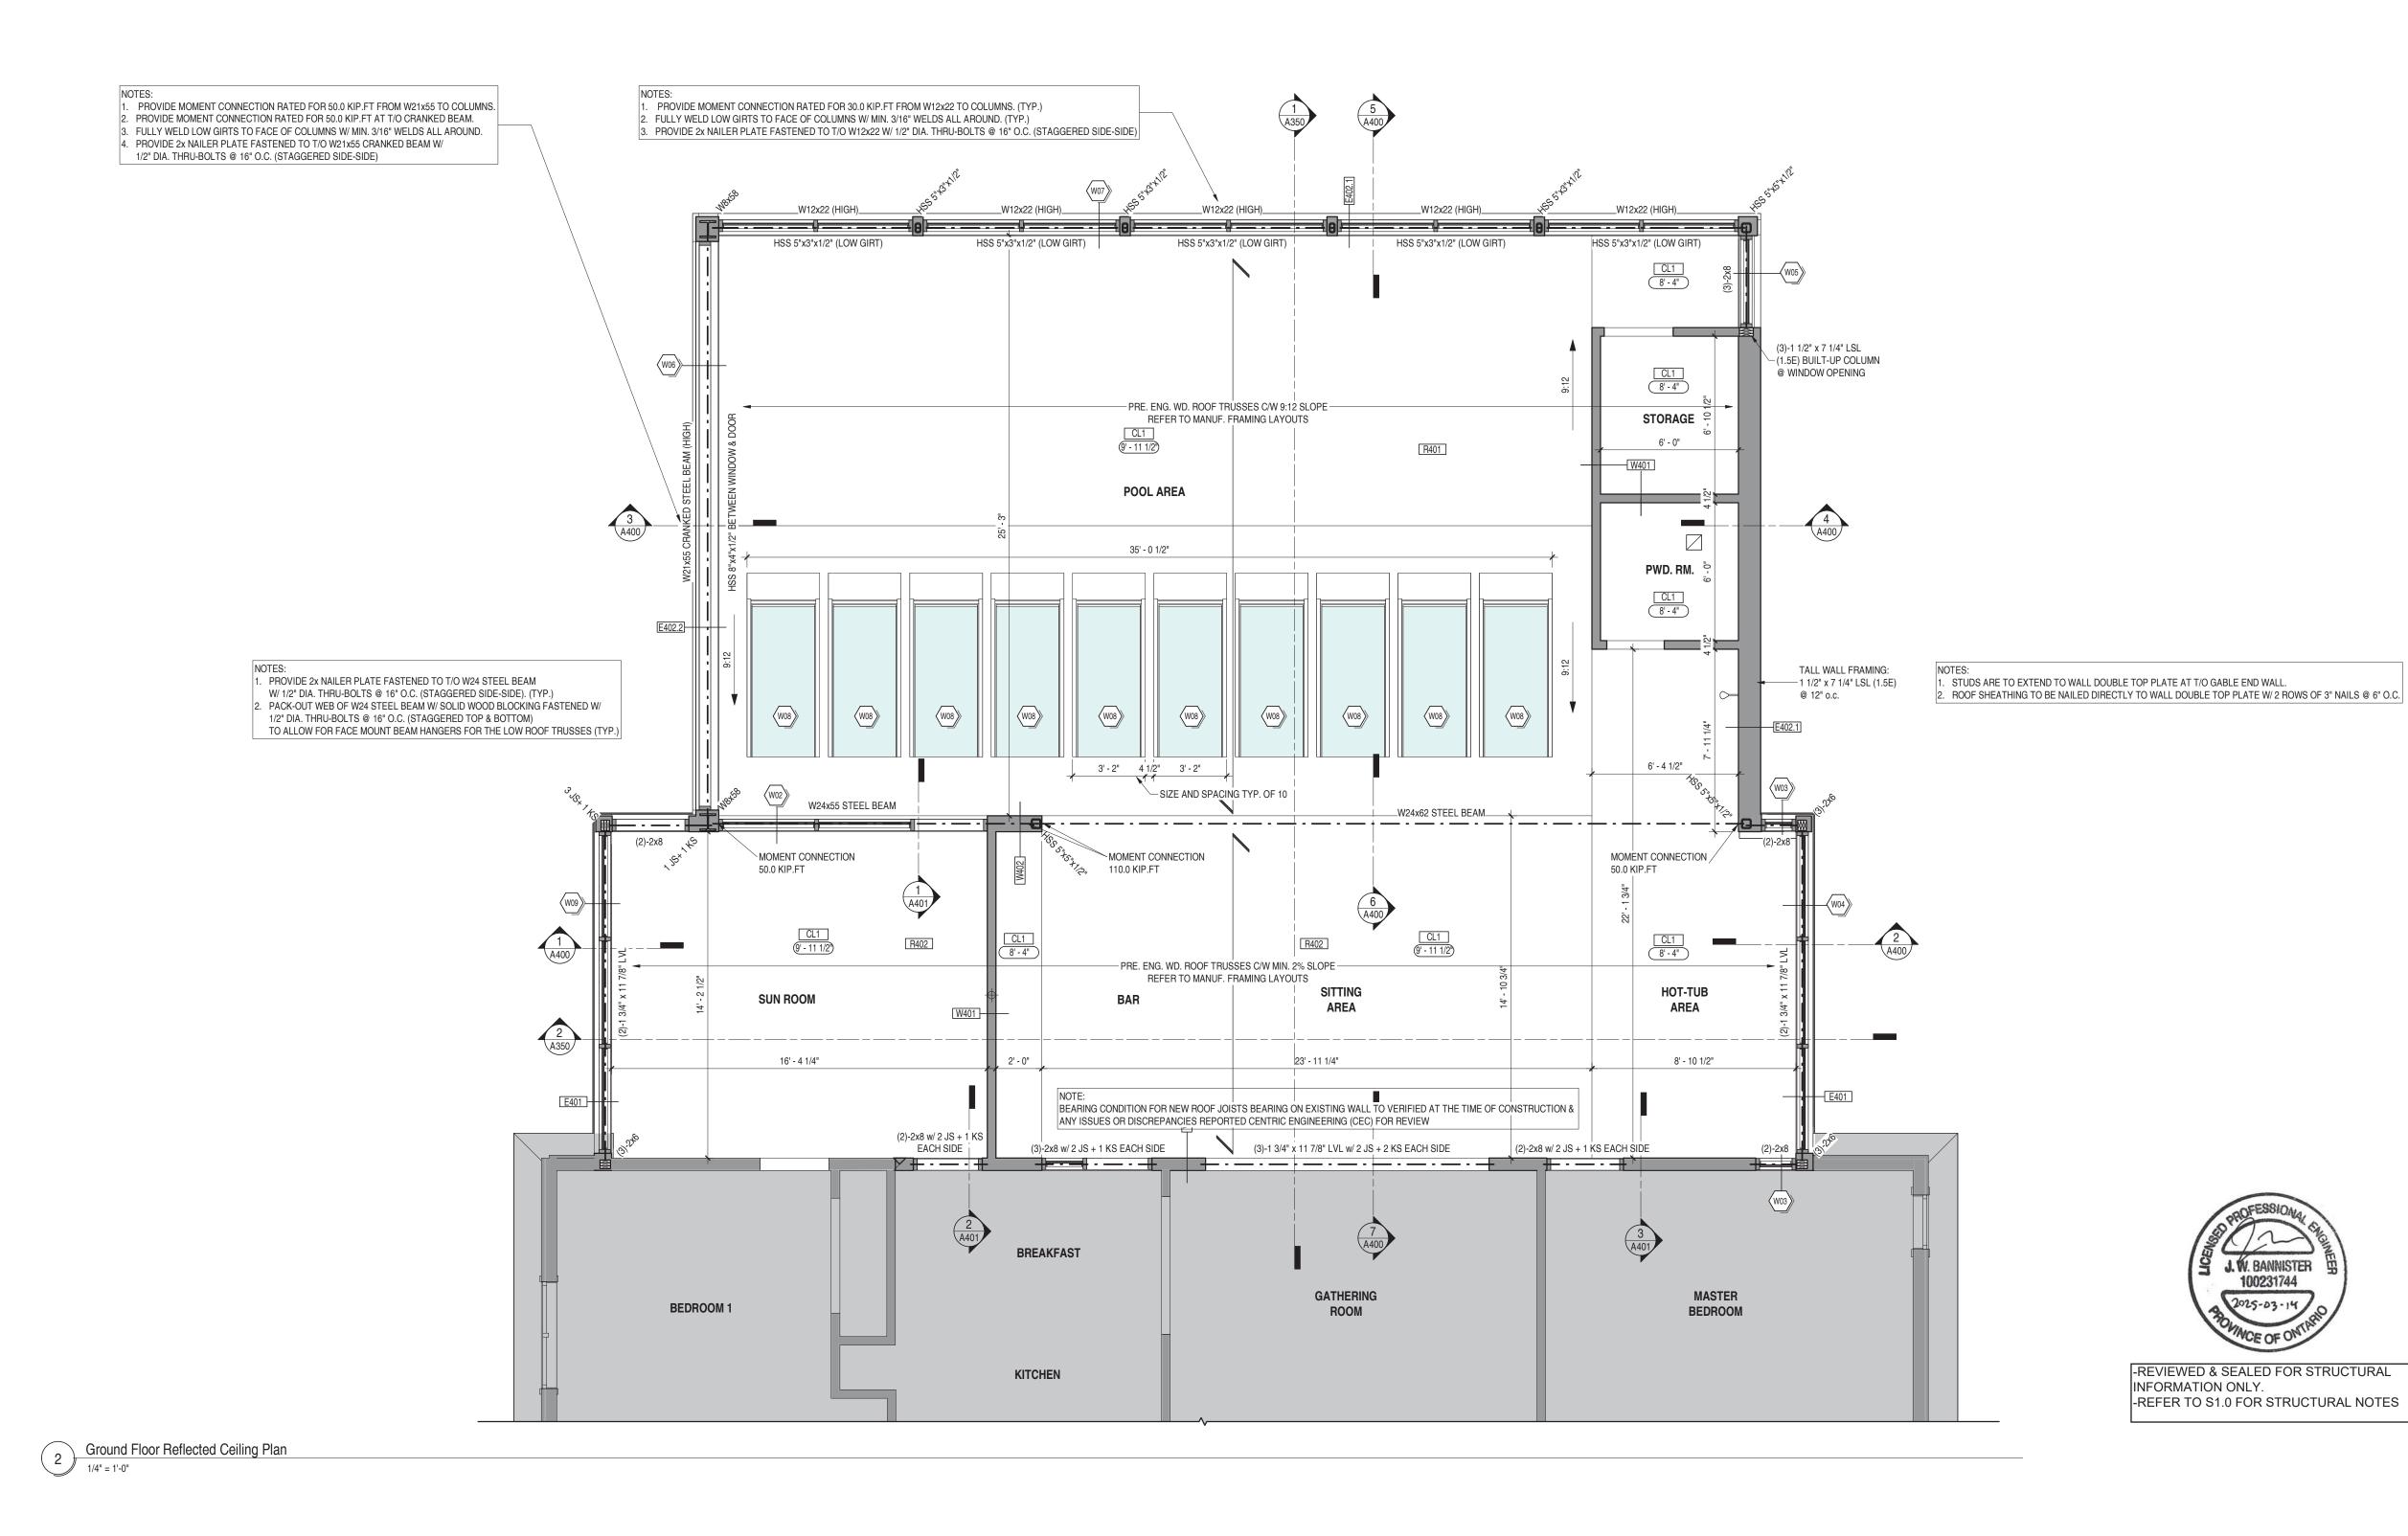

CE	EILING PLAN LEGEND
0	POT LIGHT, SEE ELEC. DWGS.
۲	DIRECTIONAL POT LIGHT, SEE ELEC. DWGS.
\otimes	CEILING MOUNTED LIGHT FIXTURE, SEE ELEC. DWGS.
НØ	WALL MOUNTED LIGHT FIXTURE, SEE ELEC. DWGS.
\geq	RECESSED LIGHT FIXTURE, SEE ELEC. DWGS.
	SUSPENDED LIGHT FIXTURE, SEE ELEC. DWGS.
	EXHAUST FAN, SEE MECH. DWGS.
	SUPPLY AIR DIFFUSER, SEE MECH. DWGS.
	RETURN AIR GRILLE, SEE MECH. DWGS.
[]	LINEAR SUPPLY AIR DIFFUSER, SEE MECH. DWGS.
	FIRE SPRAY INSULATION AT U/S OF STRUCTURE
CLG 2750	DENOTES CEILING TYPE AND CEILING HEIGHT, SEE ASSEMBLY SCHEDULE
CI	EILING PLAN NOTES
2. ALI OT 3. AR HA OT 4. RE ELI AR 5. RE 5. RE AR CO 5. RE CO 6. EX CO 6. EX CO CO 5. RE AR 7. LIG FO SH DR	L LIGHT FIXTURES ARE TO BE CENTRED WITHIN ROOM ILESS NOTED OTHERWISE. L CEILINGS ARE GYPSUM BOARD UNLESS NOTED HERWISE. IEAS THAT ARE NOT DENOTED WITH A CEILING TAG NOR TCHING ARE TO BE LEFT EXPOSED UNLESS NOTED HERWISE. FER TO ELECTRICAL DRAWINGS FOR FULL SCOPE OF ECTRICAL DEVICES AND SPECIFICATIONS. NOTIFY THE ICHITECT OF ANY FOUND DISCREPANCIES AND/OR INFLICTS. FER TO MECHANICAL DRAWINGS FOR FULL SCOPE OF ECHANICAL DEVICES AND SPECIFICATIONS. NOTIFY THE ICHITECT OF ANY FOUND DISCREPANCIES AND/OR INFLICTS. TENT OF SPRINKLER SYSTEM NOT SHOWN. GENERAL INTRACTOR TO SUPPLY AND INSTALL SPRINKLER STEM TO APPLICABLE CODES TO SUIT PLANS. INERAL CONTRACTOR TO SUPPLY SHOP DRAWINGS IN SPRINKLER SYSTEM PRIOR TO INSTALLATION TO THE ICHITECT FOR REVIEW AND APPROVAL. BHT FIXTURES AND MECHANICAL DUCTWORK/ FFUSRS/ RETURN AIR GRILLES/ EQUIPMENT SHOWN IR COORDINATION ONLY. NOT ALL FIXTURES ARE IOWN. REFER TO MECHANICAL AND ELECTRICAL IAWINGS FOR MORE INFORMATION/ QUANTITY/ DUNTING HEIGHTS/ ETC.

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No.	DATE	ISSUE



1404 Doon Village Road, Kitchener On, N2P 1A5 PROJECT 1404 Doon Village Oasis


1404 Doon Village Road, Kitchener On, N2P 1A5 DRAWING

Reflected Ceiling Plan





-REVIEWED & SEALED FOR STRUCTURAL INFORMATION ONLY. -REFER TO S1.0 FOR STRUCTURAL NOTES

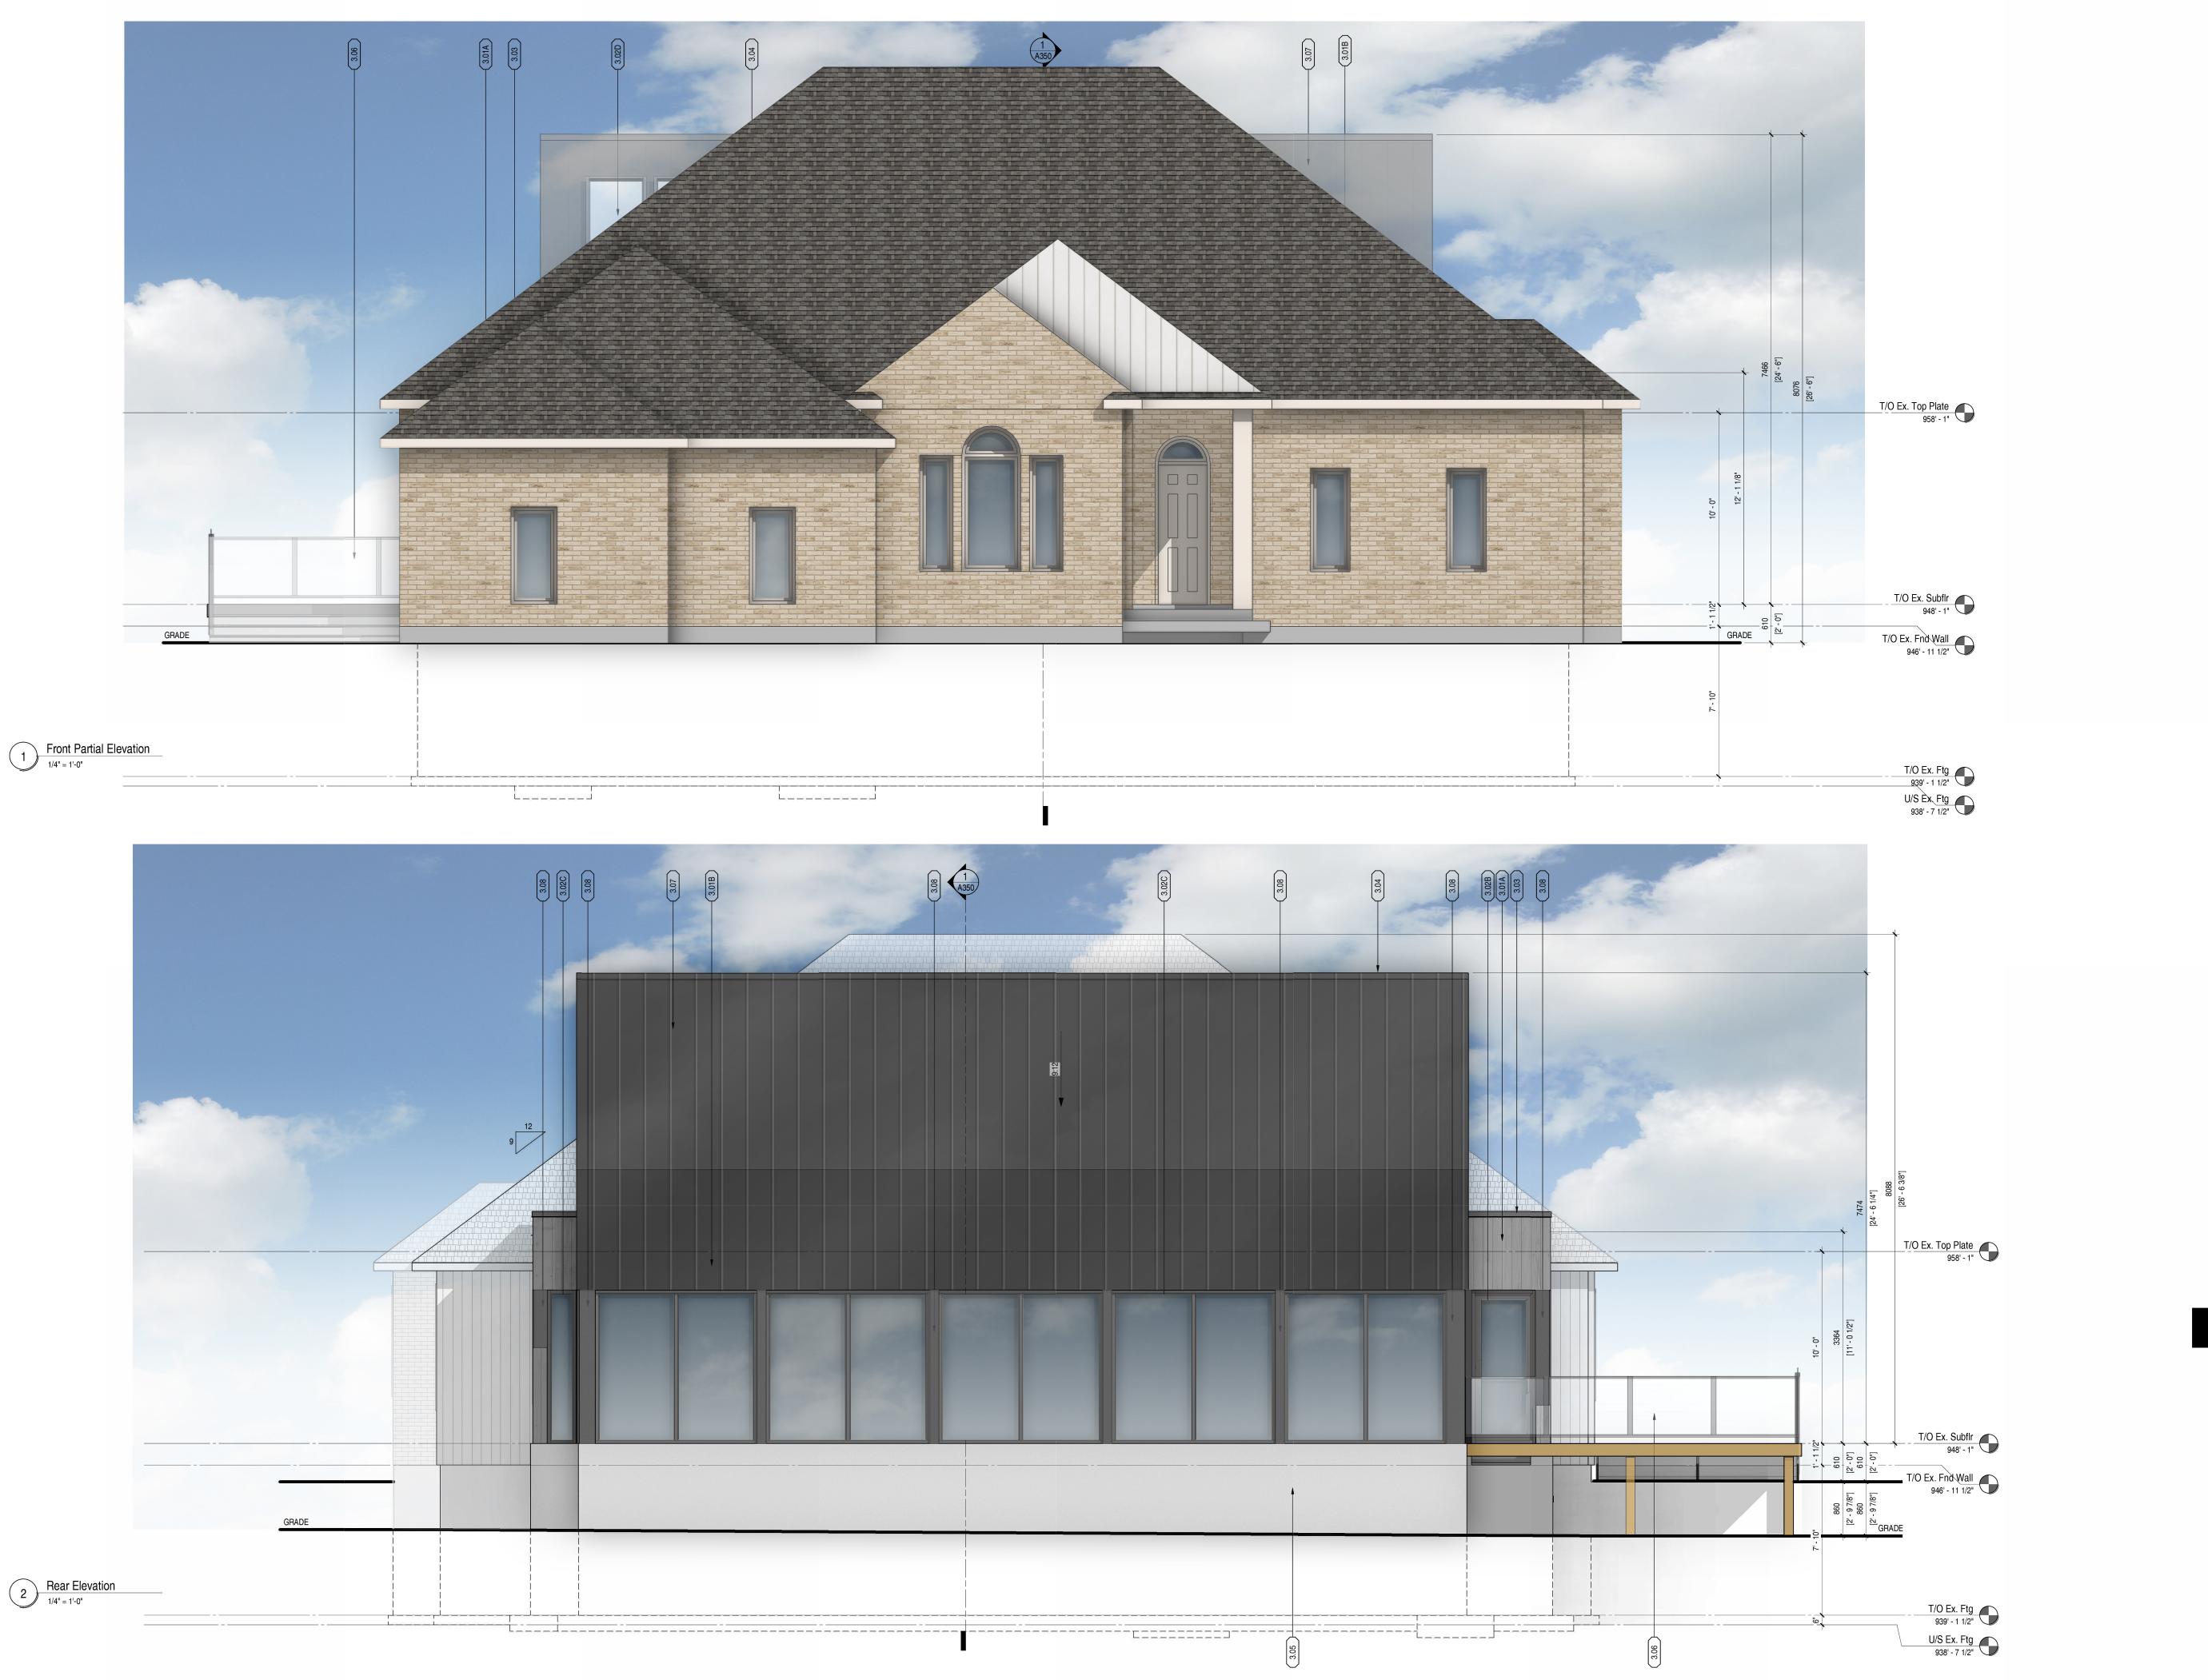

KEYNOTE LEGEND

3.01A	PREFINISHED VERTICAL METAL SIDING (MANUFACTURER: METALUNIC / VICWEST) (STYLE: MODERNO / BELLARA PLANK) (SERIES: WOODSHADE / EXPRESSENCE) (COLOUR: URBAN GREY 783 QC182535 / RIVER ROCK GRAY 18-0254)
3.01B	OR SIMILAR & APPROVED ALTERNATE PREFINISHED VERTICAL STANDING SEAM METAL ROOFING (MANUFACTURER: IDEAL ROODING / AGWAY) (STYLE: HERITAGE SERIES, STIFFENER RIBS REMOVED / AR STANDING SEAM, NO STIFFENER FLUTES) (COLOUR: JET BLACK TEXTURED ID 60039 / EBONY WRINKLE COAT QC 09822) OR SIMILAR & APPROVED ALTERNATE
3.02B	PREFINISHED ALUMINUM ENTRY DOOR SYSTEM c/w STEEL INSULATED DOOR PANEL. REFER TO DOOR SCHEDULE & ELEVATIONS FOR DETAILS.
3.02C	THERMALLY BROKEN EXTRUDED ALUMINUM WINDOW WALL FRAME SYSTEM C/W INSULATED SEALED DOUBLE GLAZING
3.02D	THERMALLY BROKEN EXTRUDED ALUMINUM SKYLIGHT FRAME SYSTEM C/W INSULATED SEALED DOUBLE GLAZING
3.03	PREFINISHED BENT METAL FLASHING (COLOUR: TBD, TO MATCH SIDING BELOW)
3.04	PREFINISHED METAL RIDGE CAP (COLOUR: TO MATCH ROOFING)
3.05	CONCRETE FOUNDATION WALL (FINISH: SANDBLASTED)
3.06	TEMPERED GLASS GUARDRAIL c/w PREFINISHED EXTRUDED ALUMINUM POSTS AND TOP & BOTTOM RAIL(S). REFER TO SECTIONS FOR HEIGHT REQUIREMENTS. (MANUFACTURER: GRECO) (PROFILE: C12 C/W GAR-R7 TOP RAIL) (COLOUR: GAR 800 GREY)
3.07	PREFINISHED VERTICAL STANDING SEAM METAL ROOF (MANUFACTURER: TBD/ STYLE: TBD/ COLOUR: DARK GREY)
3.08	PREFINISHED FIBER-CEMENT PANEL (MANUFACTURER: JAMESHARDIE) (FINISH: SMOOTH) (SERIES: STATEMENT COLLECTION) (COLOUR: MIDNIGHT BLACK)

BUILDING PERMIT

8	Mar 28/25	Issued for Heritage Permit
7	Mar 14/25	Issued for Building Permit
6	Dec 03/24	Issued for Budget Costing
3	Nov 4/24	Issued for Coordination
2	Oct 22/24	Issued for Coordination
1	Sept 27/24	Issued for Coordination
No.	DATE	ISSUE



1404 Doon Village Road, Kitchener On, N2P 1A5 PROJECT 1404 Doon Village Oasis

1404 Doon Village Road, Kitchener On, N2P 1A5

Building Elevations

PROJECT No. 24-008 PROJECT DATE September 23, 2024 DRAWN BY zschickler



KEYNOTE LEGEND

3.01A	PREFINISHED VERTICAL METAL SIDING (MANUFACTURER: METALUNIC / VICWEST) (STYLE: MODERNO / BELLARA PLANK) (SERIES: WOODSHADE / EXPRESSENCE) (COLOUR: URBAN GREY 783 QC182535 / RIVER ROCK GRAY 18-0254) OR SIMILAR & APPROVED ALTERNATE
3.01B	PREFINISHED VERTICAL STANDING SEAM METAL ROOFING (MANUFACTURER: IDEAL ROODING / AGWAY) (STYLE: HERITAGE SERIES, STIFFENER RIBS REMOVED / AR STANDING SEAM, NO STIFFENER FLUTES) (COLOUR: JET BLACK TEXTURED ID 60039 / EBONY WRINKLE COAT QC 09822) OR SIMILAR & APPROVED ALTERNATE
3.02A	PREFINISHED VINYL SLIDING DOOR. OPERABLE PANEL SHOWN w/ DASHED LINES. REFER TO DOOR SCHEDULE & ELEVATIONS FOR DETAILS.
3.02C	THERMALLY BROKEN EXTRUDED ALUMINUM WINDOW WALL FRAME SYSTEM C/W INSULATED SEALED DOUBLE GLAZING
3.03	PREFINISHED BENT METAL FLASHING (COLOUR: TBD, TO MATCH SIDING BELOW)
3.04	PREFINISHED METAL RIDGE CAP (COLOUR: TO MATCH ROOFING)
3.05	CONCRETE FOUNDATION WALL (FINISH: SANDBLASTED)
3.06	TEMPERED GLASS GUARDRAIL c/w PREFINISHED EXTRUDED ALUMINUM POSTS AND TOP & BOTTOM RAIL(S). REFER TO SECTIONS FOR HEIGHT REQUIREMENTS. (MANUFACTURER: GRECO) (PROFILE: C12 C/W GAR-R7 TOP RAIL) (COLOUR: GAR 800 GREY)
3.08	PREFINISHED FIBER-CEMENT PANEL (MANUFACTURER: JAMESHARDIE) (FINISH: SMOOTH) (SERIES: STATEMENT COLLECTION) (COLOUR: MIDNIGHT BLACK)

U/S Ex. Ftg 938' - 7 1/2"

BUILDING	PERMIT
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No.	DATE	ISSUE




OWNER


1404 Doon Village Road, Kitchener On, N2P 1A5 PROJECT 1404 Doon Village Oasis


1404 Doon Village Road, Kitchener On, N2P 1A5

Building Elevations

PROJECT No. 24-008 PROJECT DATE September 23, 2024 DRAWN BY A301 zschickler

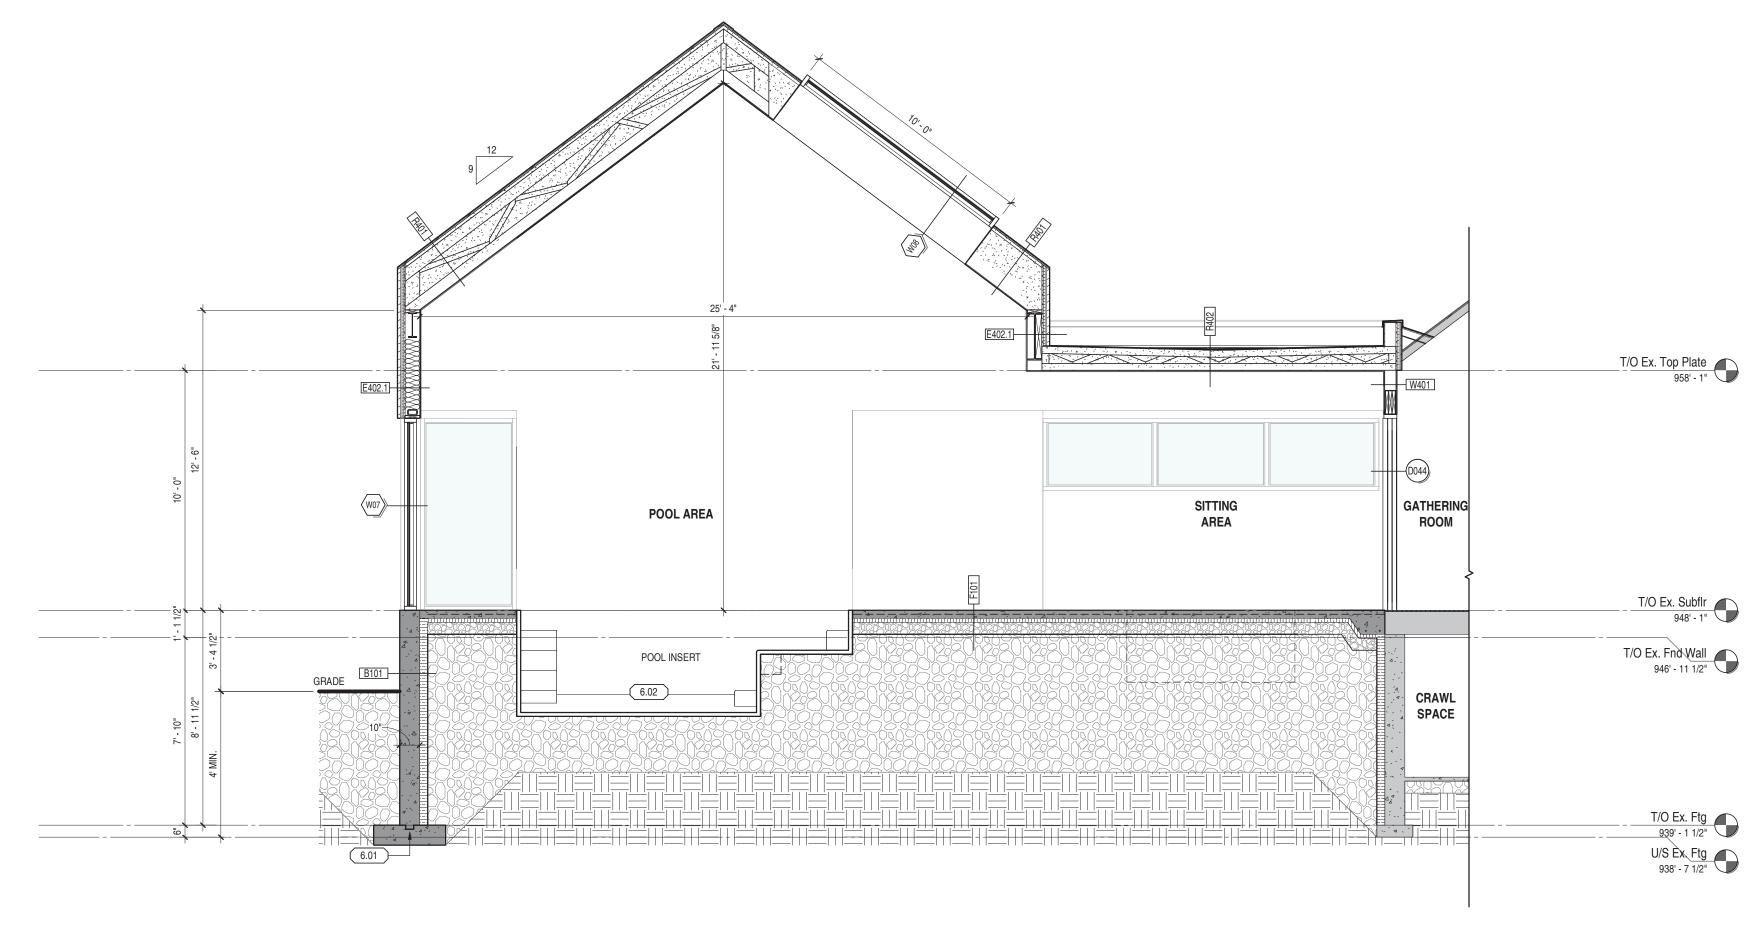

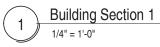

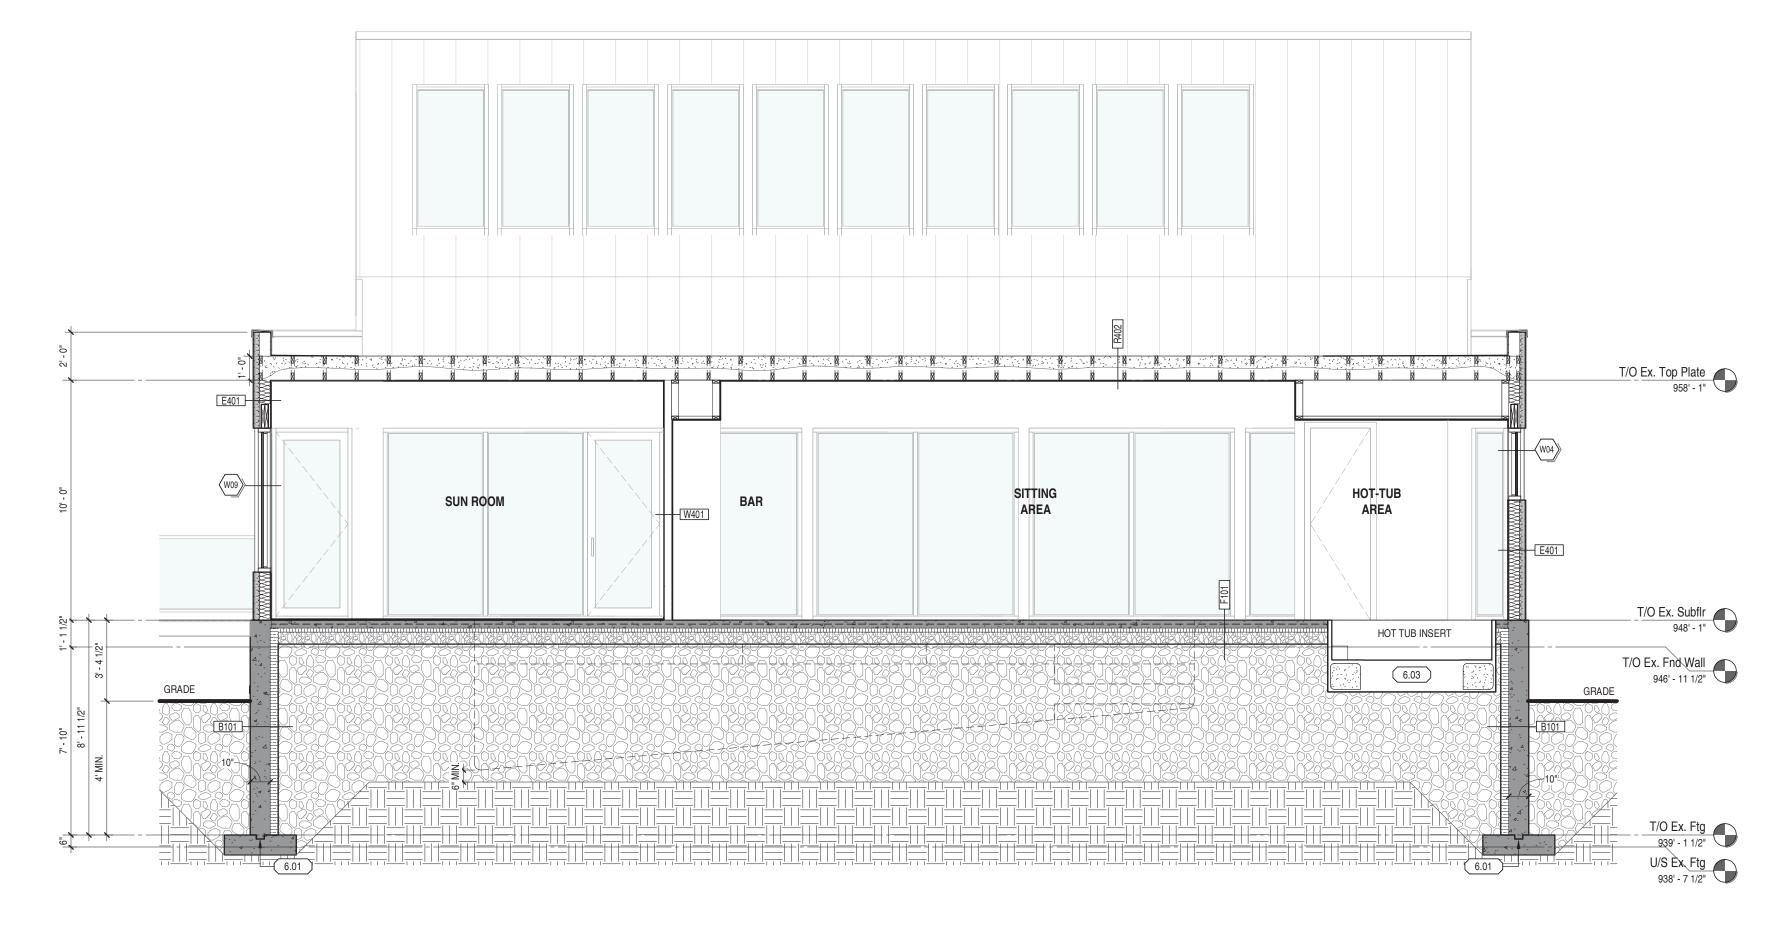

2 Building Section 2 1/4" = 1'-0"

KEYNOTE LEGEND

6.01	CONT. 2x4" SHEAR KEY NOTCH
6.02	PREFABRICATED FIBERGLASS POOL INSERT C/W
	PLUMBING & SYSTEMS AS REQUIRED
	(MANUFACTURER: LATHAM POOLS) (MODEL:
	PROVIDENCE 14) OR APPROVED ALTERNATIVE
6.03	PREFINISHED IN-GROUND HOT-TUB SYSTEM C/W
	PLUMBING & SYSTEMS AS REQUIRED

BUILDING PERMIT Image: Constraint of the state of the sta


1404 Doon Village Road, Kitchener On, N2P 1A5 PROJECT 1404 Doon Village Oasis

1404 Doon Village Road, Kitchener On, N2P 1A5


Building Sections


OWNER

PROJECT No.	
24-008	
PROJECT DATE	
September 23, 2024	A350
DRAWN BY	
zschickler	

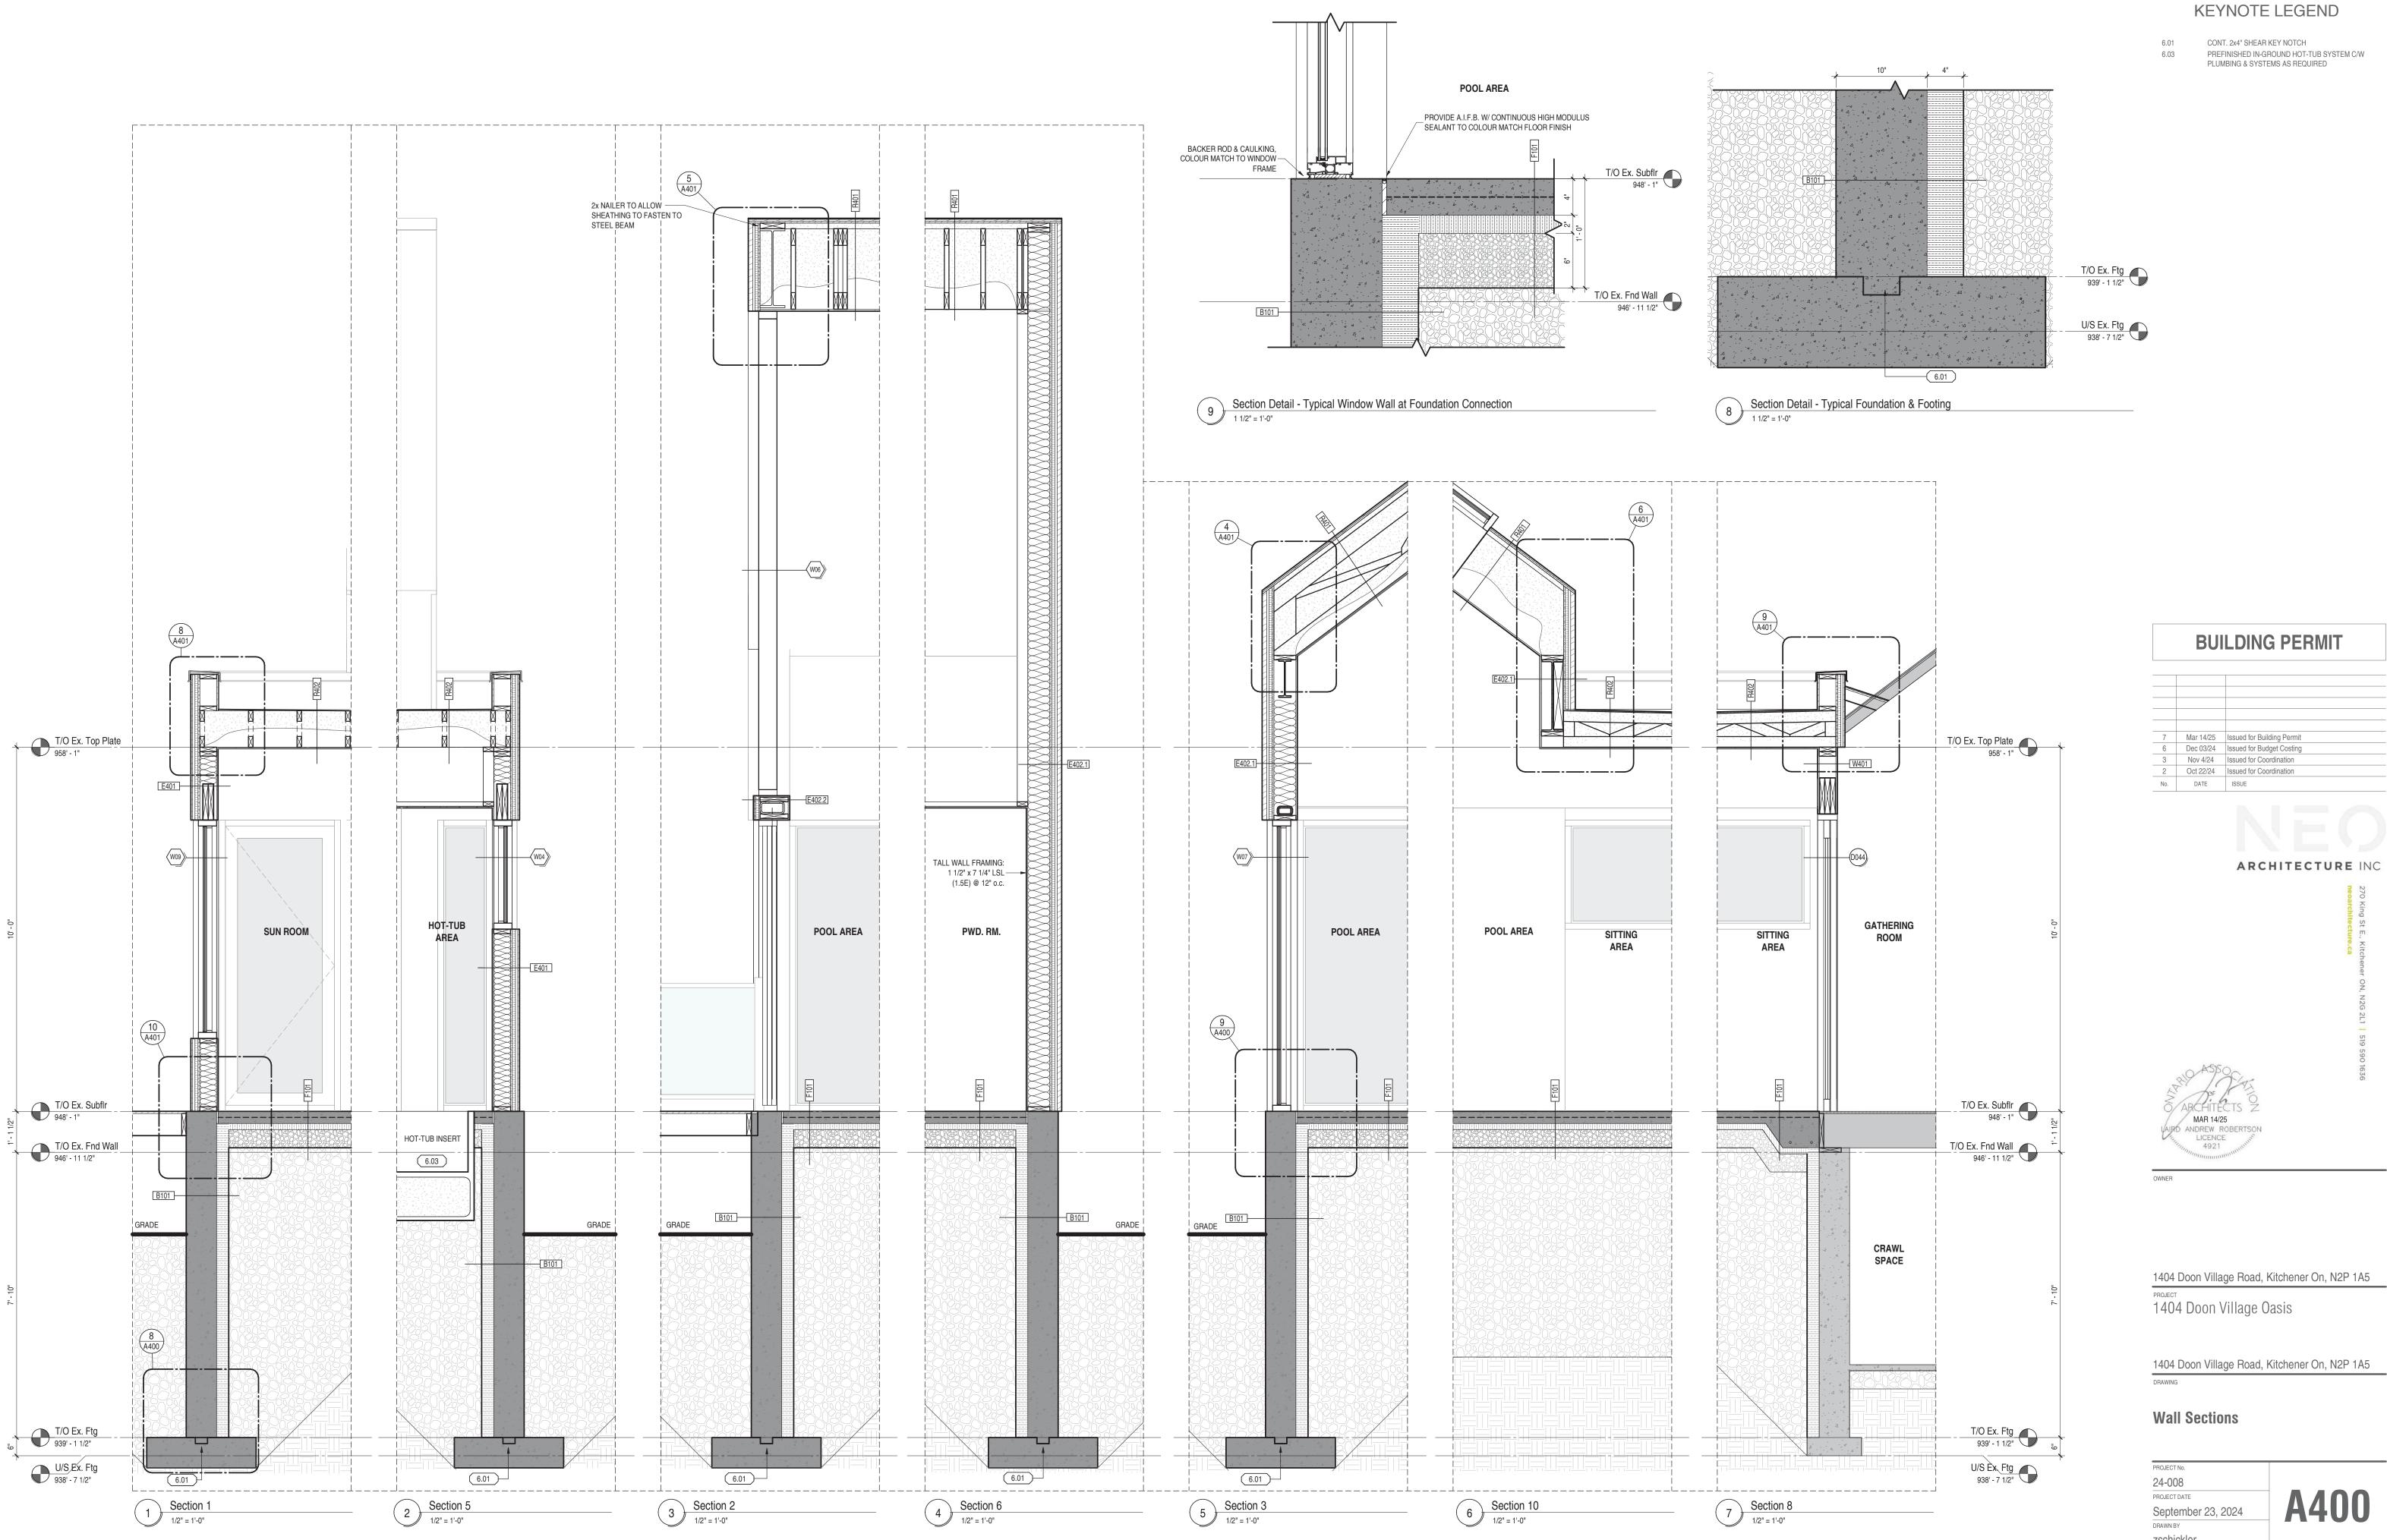



PROJECT No.	
24-008	
PROJECT DATE	
September 23, 2024	A400
DRAWN BY	
zschickler	

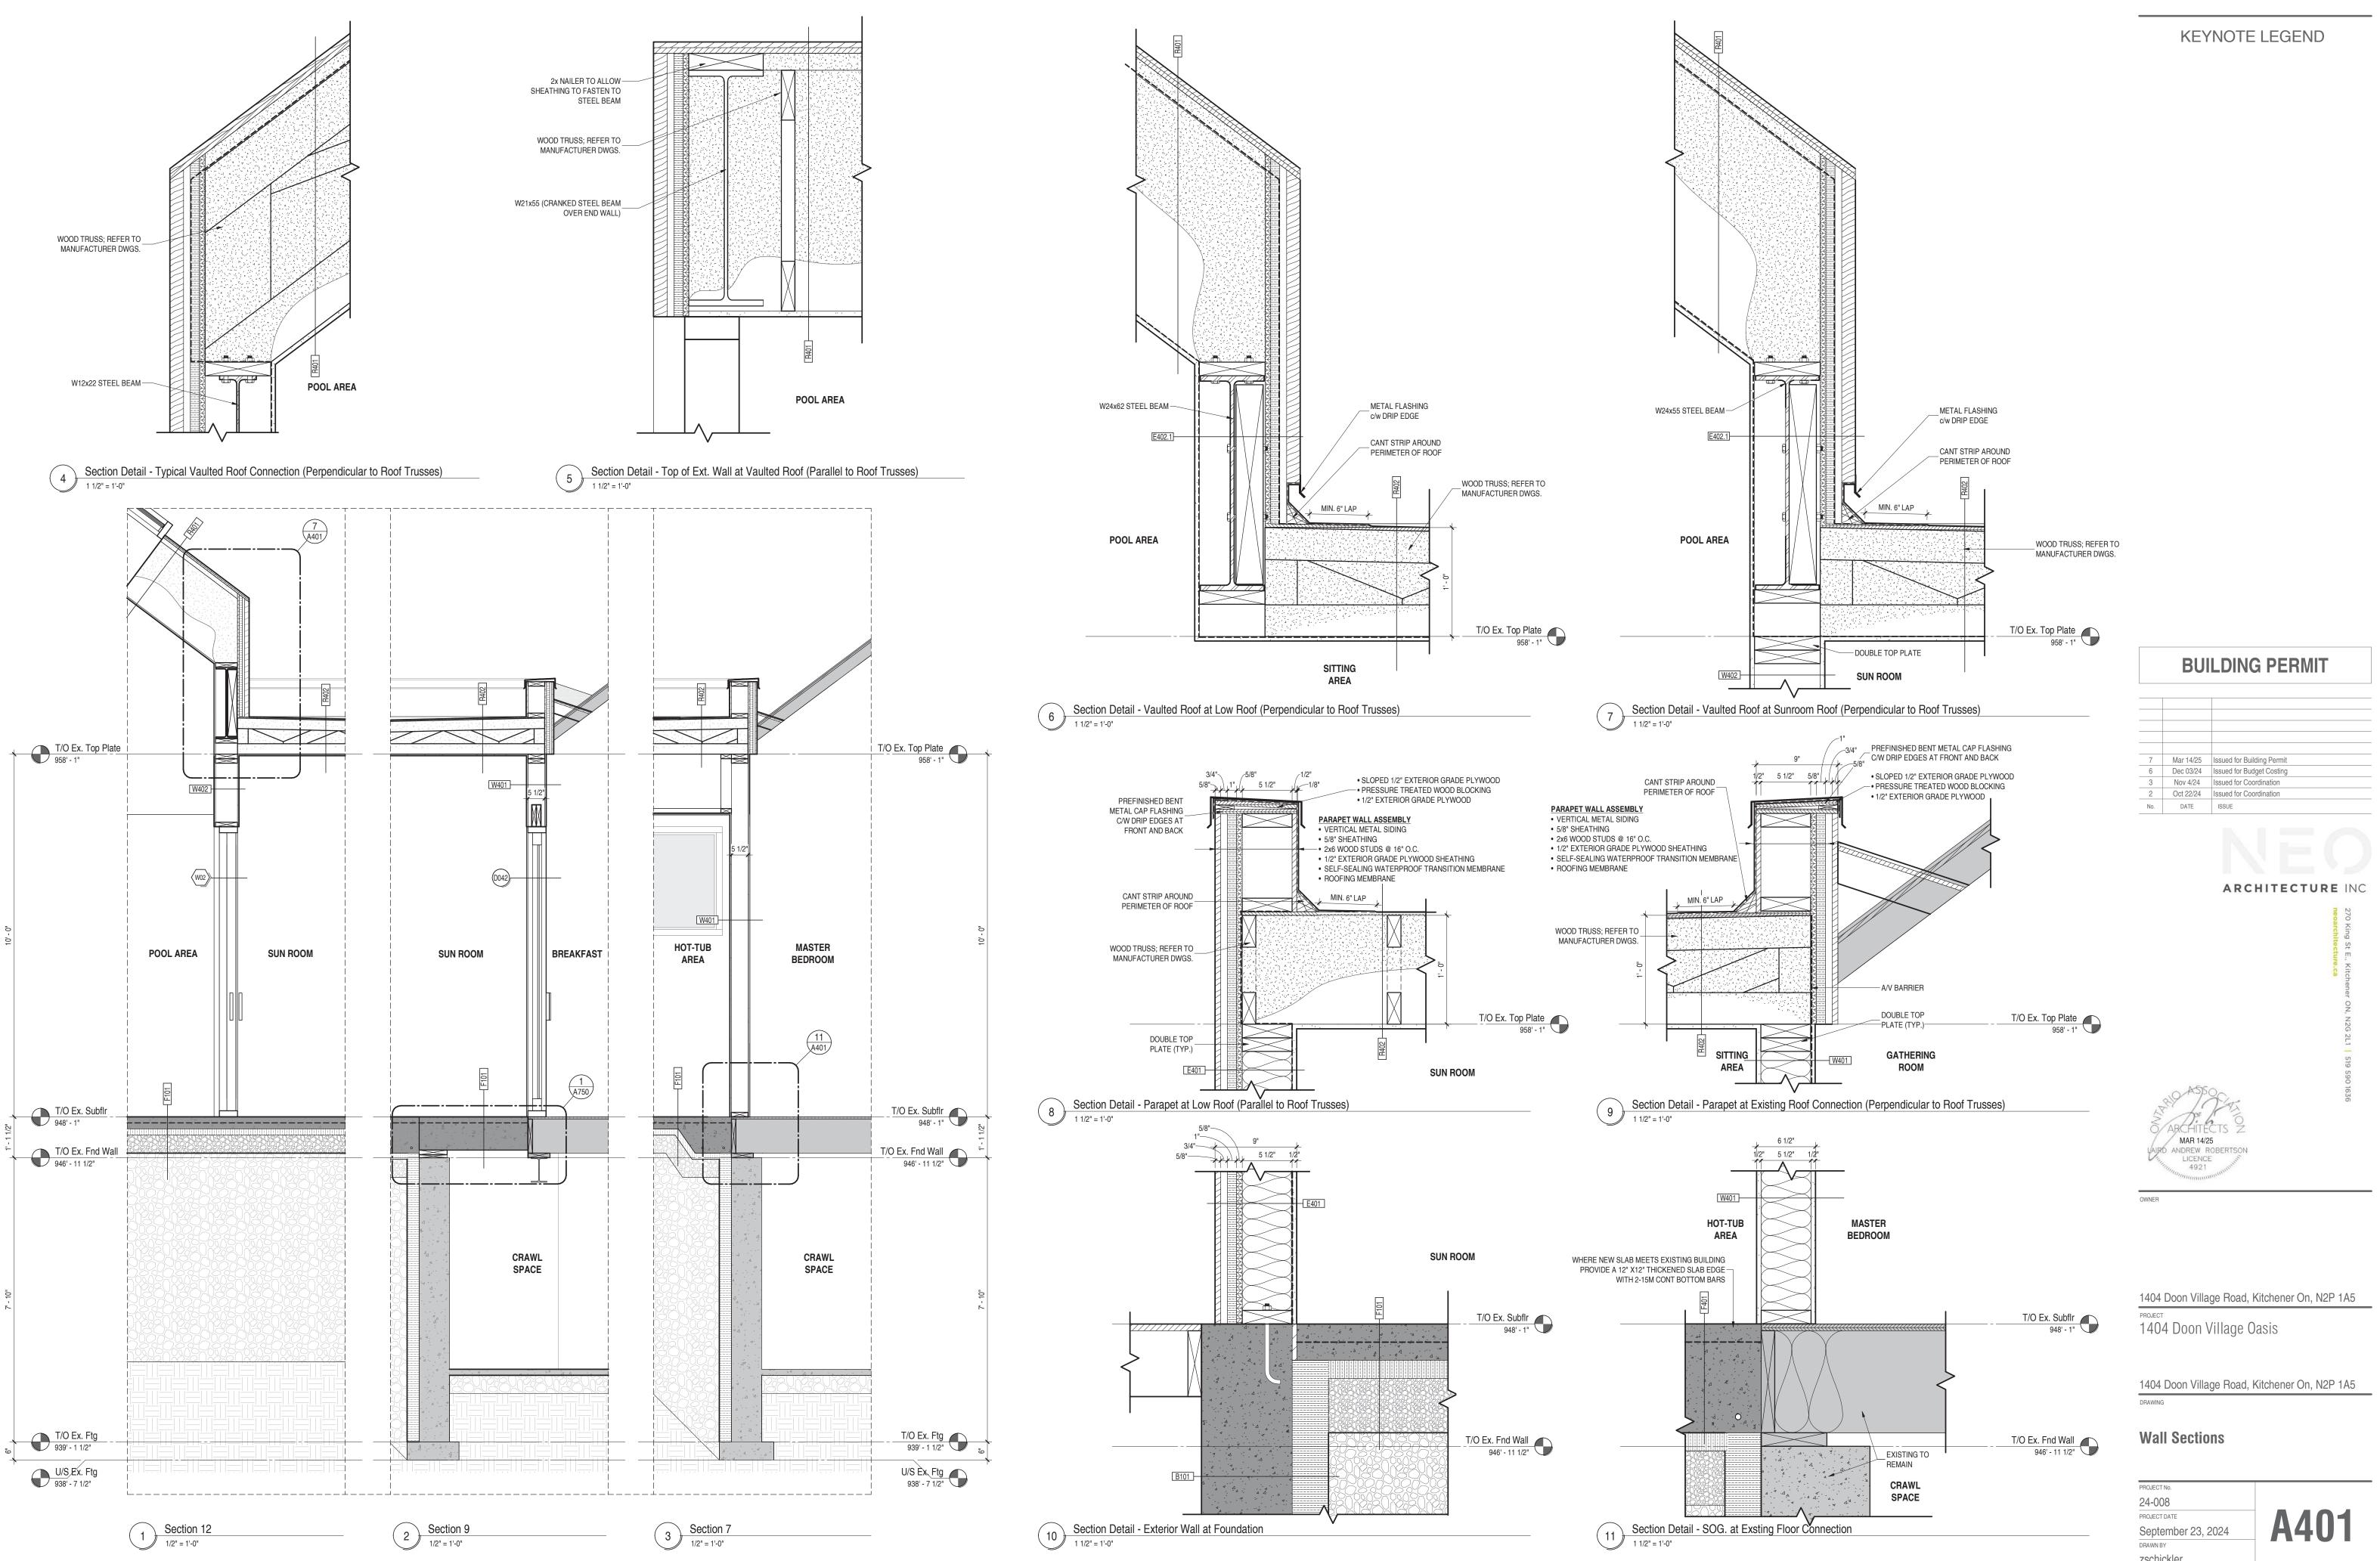

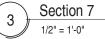


zschickler

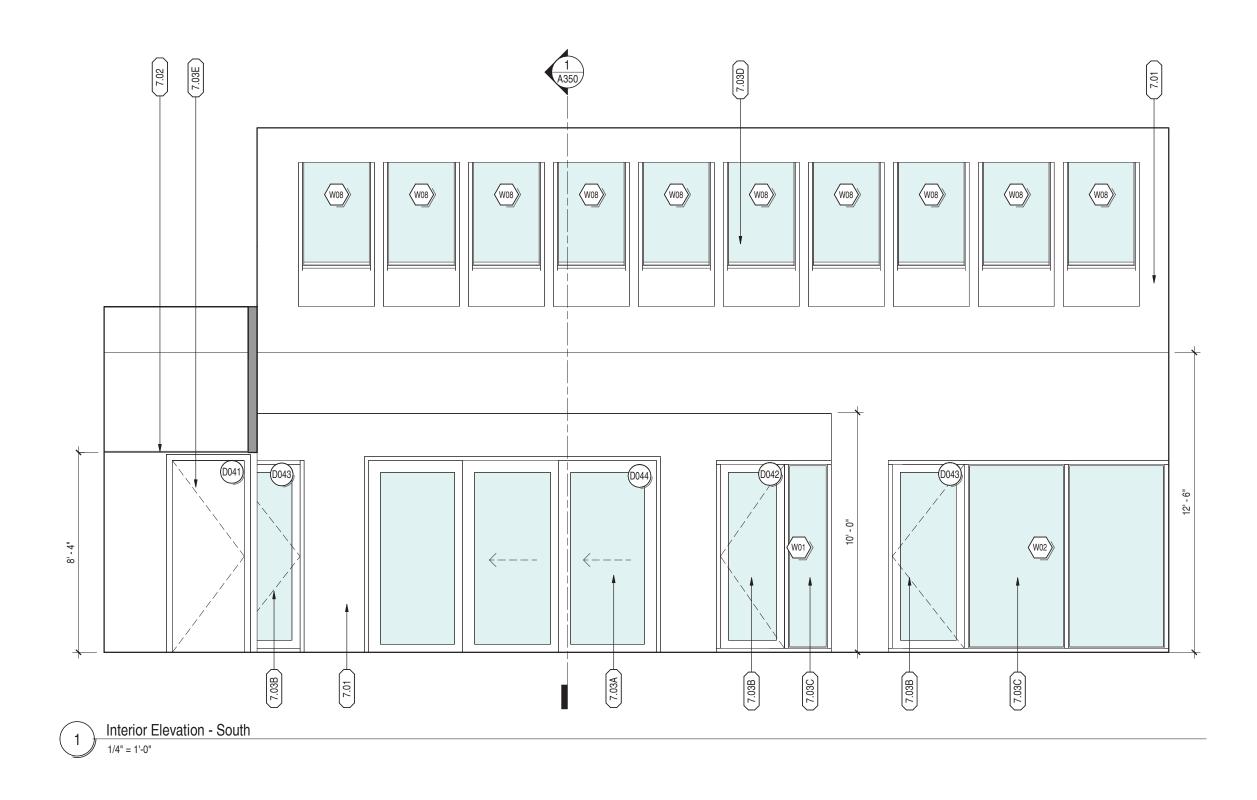

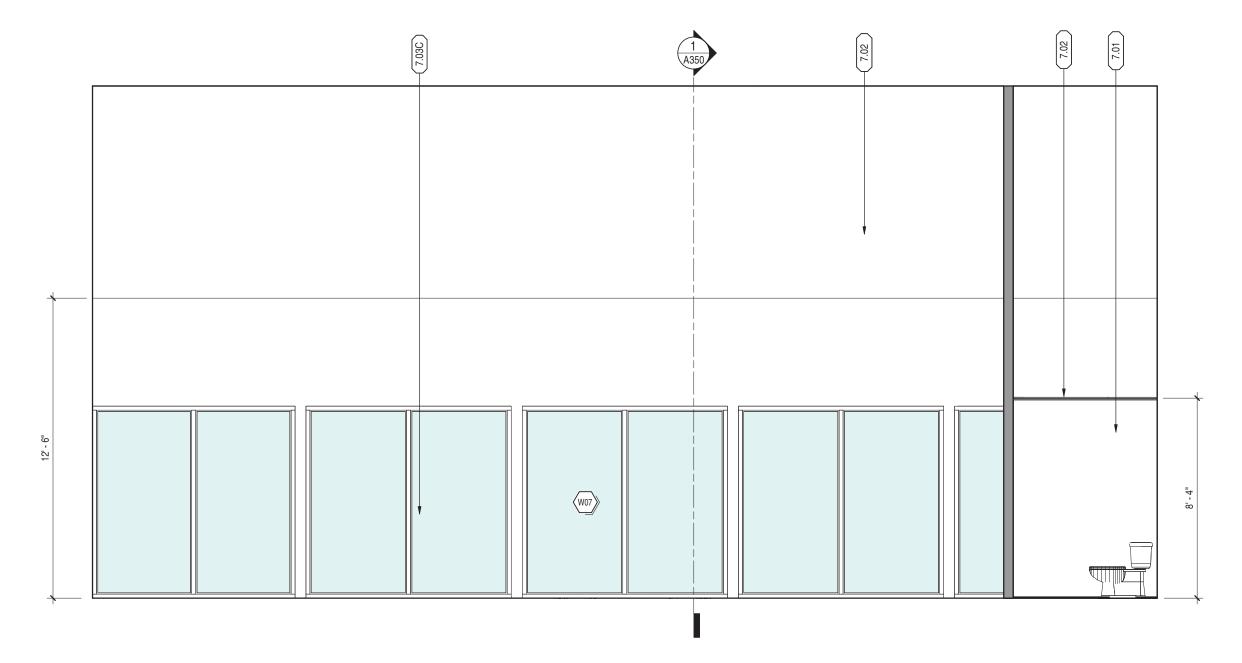






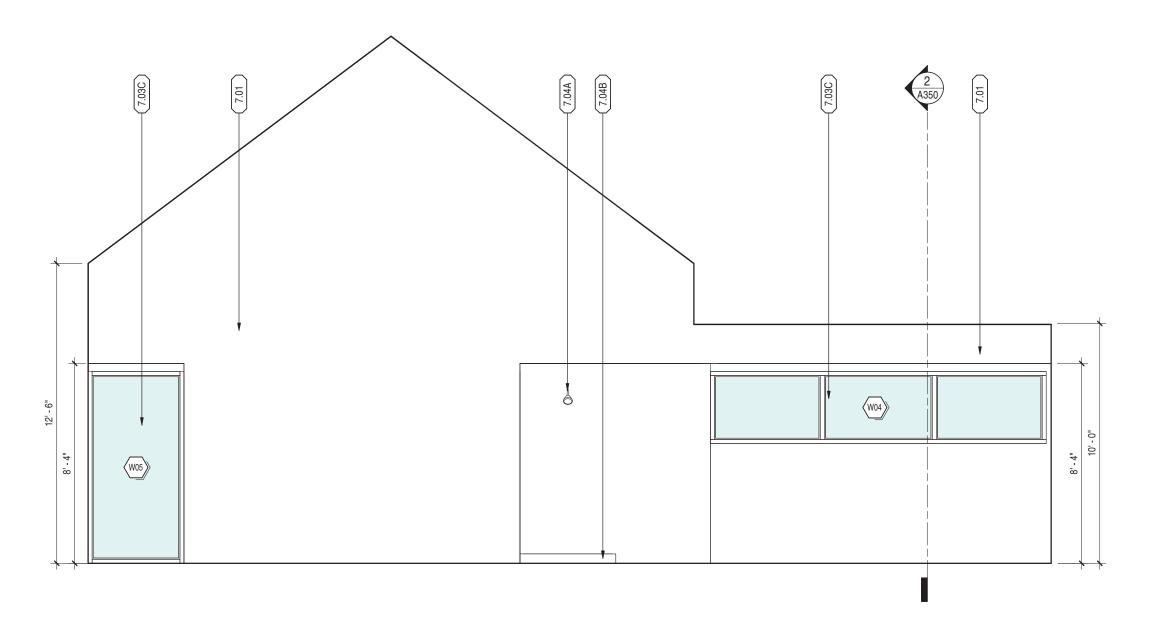



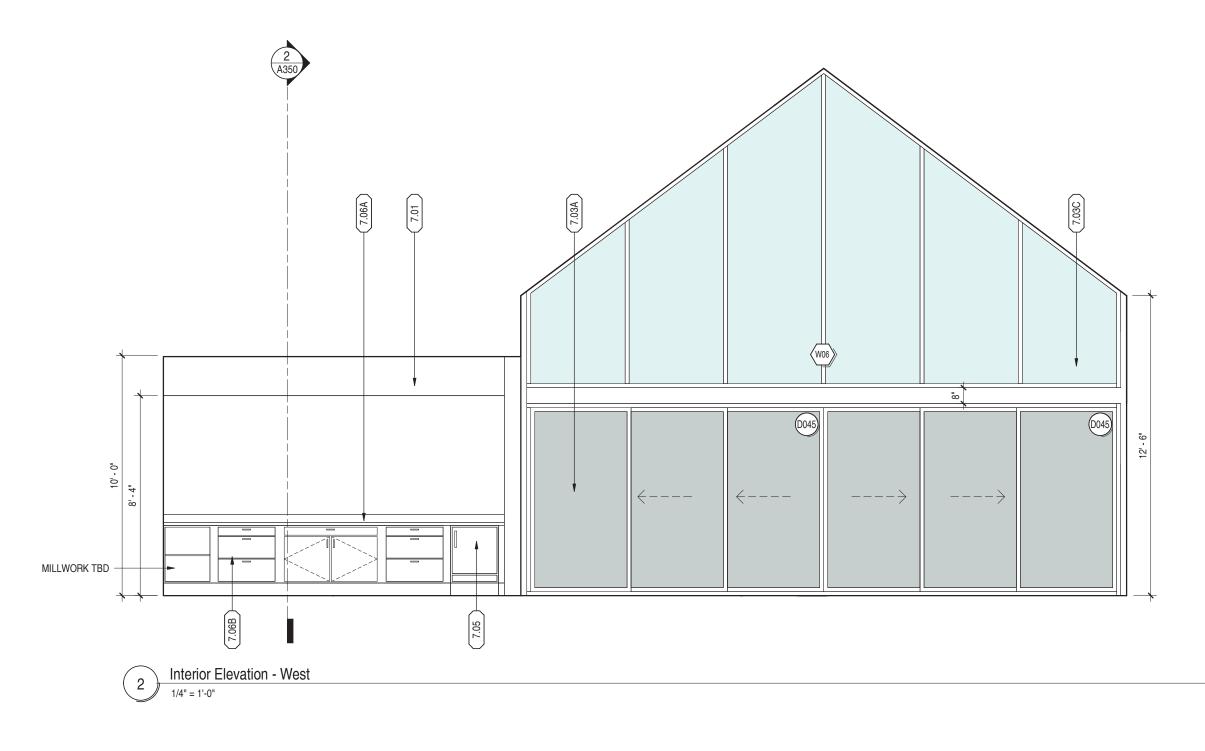

KEYNOTE LEGEND

GYPSUM WALL BOARD

7.01

7.02	GYPSUM CEILING BOARD
7.03A	PREFINISHED VINYL SLIDING DOOR. OPERABLE PANEL SHOWN W/ DASHED LINES. REFER TO DOOR SCHEDULE & ELEVATIONS FOR DETAILS.
7.03B	PREFINISHED ALUMINUM ENTRY DOOR SYSTEM c/w STEEL INSULATED DOOR PANEL. REFER TO DOOR SCHEDULE & ELEVATIONS FOR DETAILS.
7.03C	THERMALLY BROKEN EXTRUDED ALUMINUM WINDOW WALL FRAME SYSTEM C/W INSULATED SEALED DOUBLE GLAZING
7.03D	THERMALLY BROKEN EXTRUDED ALUMINUM SKYLIGHT FRAME SYSTEM C/W INSULATED SEALED DOUBLE GLAZING
7.03E	WOOD FRAMED ENTRY DOOR. REFER TO DOOR SCHEDULE & ELEVATIONS FOR DETAILS.
7.04A	SHOWER HEAD
7.04B	WALK-IN ACRYLIC SHOWER BASE C/W SHOWER HEAD & CONTROLS, REFER TO MECH. DWGS.



7.06A 7.06B COUNTERTOP

BASE CABINETS

BUILDING	PERMIT
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No.	DATE	ISSUE




1404 Doon Village Road, Kitchener On, N2P 1A5 PROJECT 1404 Doon Village Oasis

1404 Doon Village Road, Kitchener On, N2P 1A5

Interior Elevations



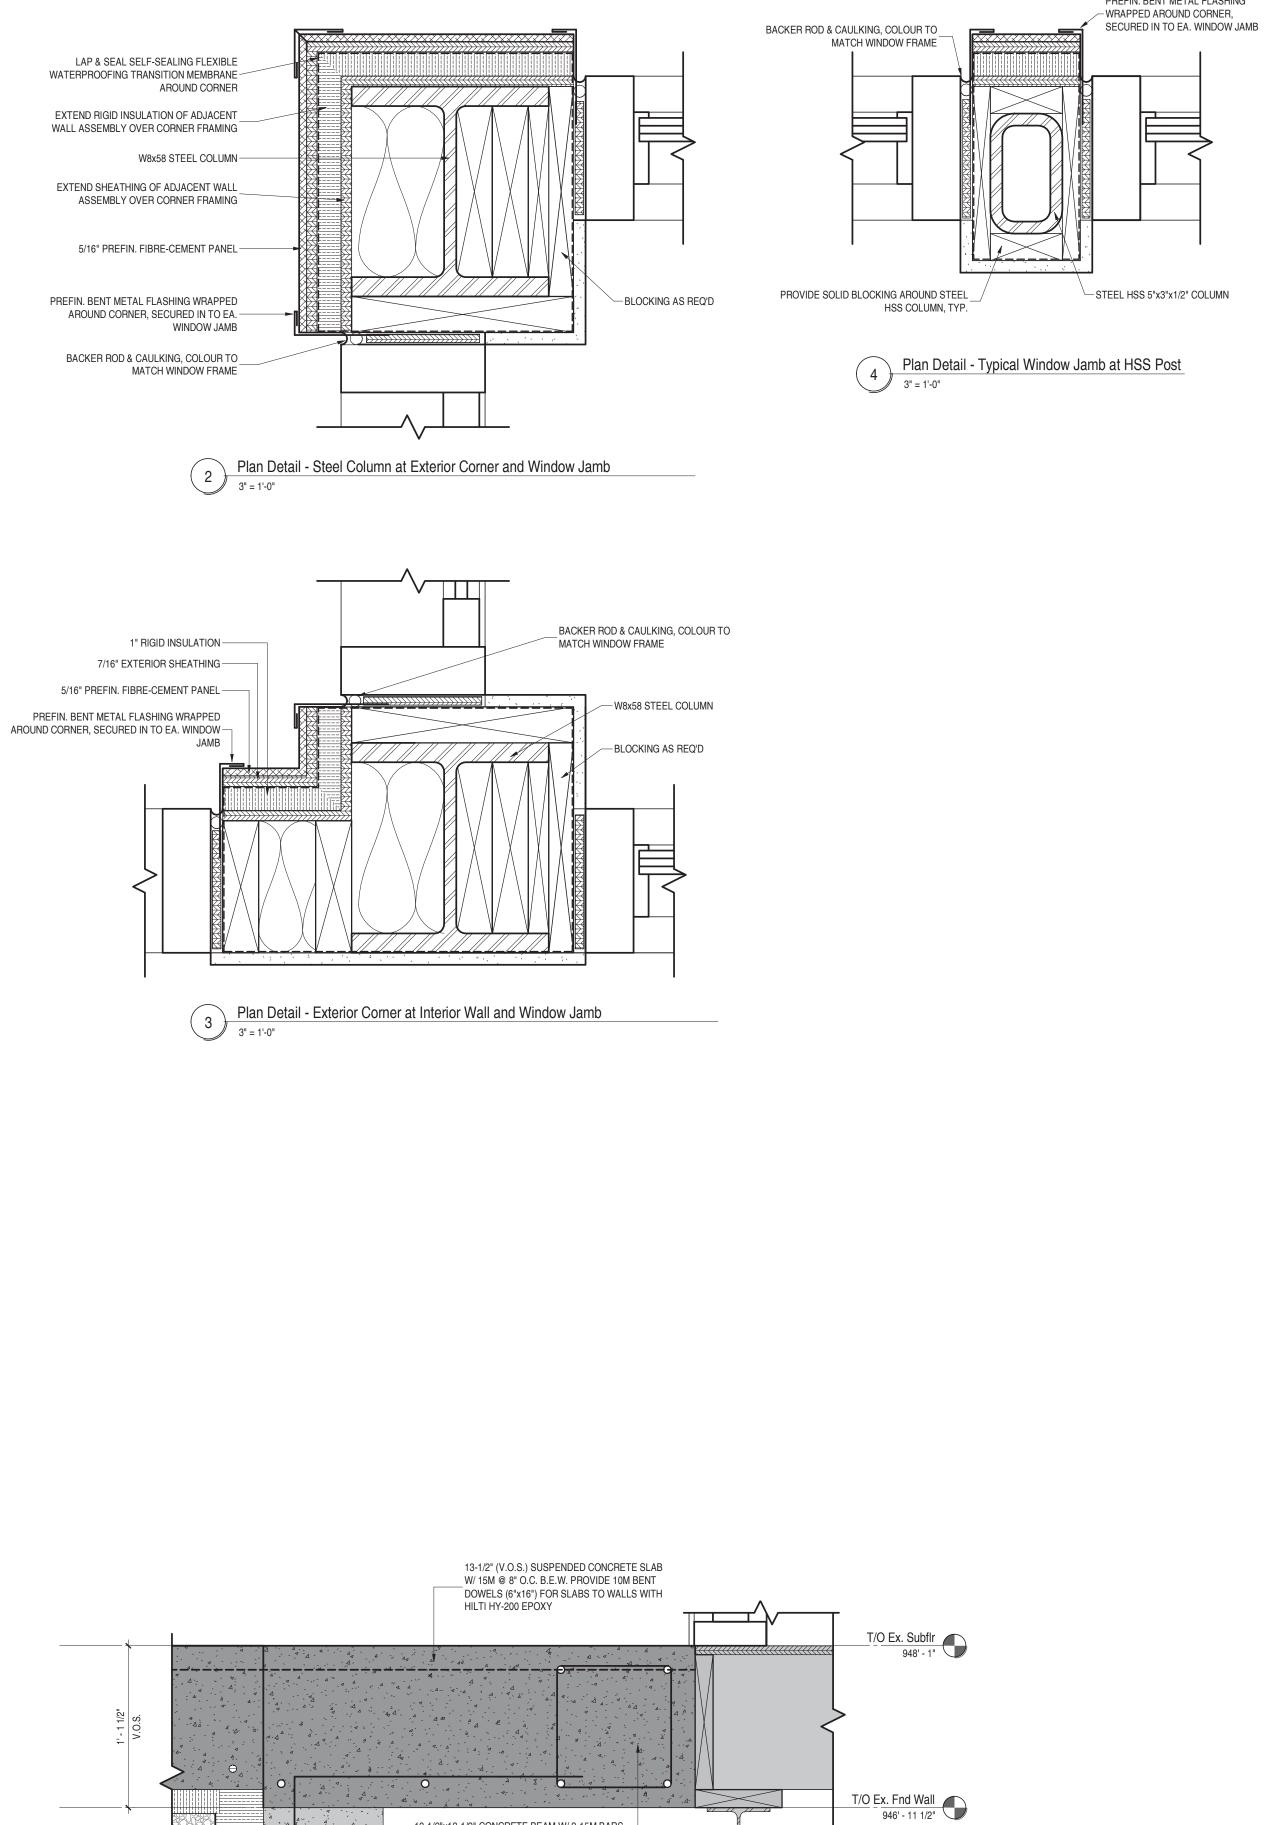

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13-1/2"x13-1/2" CONCRETE BEAM W/ 2-15M BARS _____ TOP & BOTTOM & 10M STIRRUPS @ 6" O.C.

EXISTING STEEL BEAM TO REMAIN -

PREFIN. BENT METAL FLASHING

BUILDING PERMIT




OWNER

1404 Doon Village Road, Kitchener On, N2P 1A5 PROJECT 1404 Doon Village Oasis


1404 Doon Village Road, Kitchener On, N2P 1A5


Section Details

PROJECT No.	
24-008	
PROJECT DATE	
September 23, 2024	A750
DRAWN BY	
zschickler	

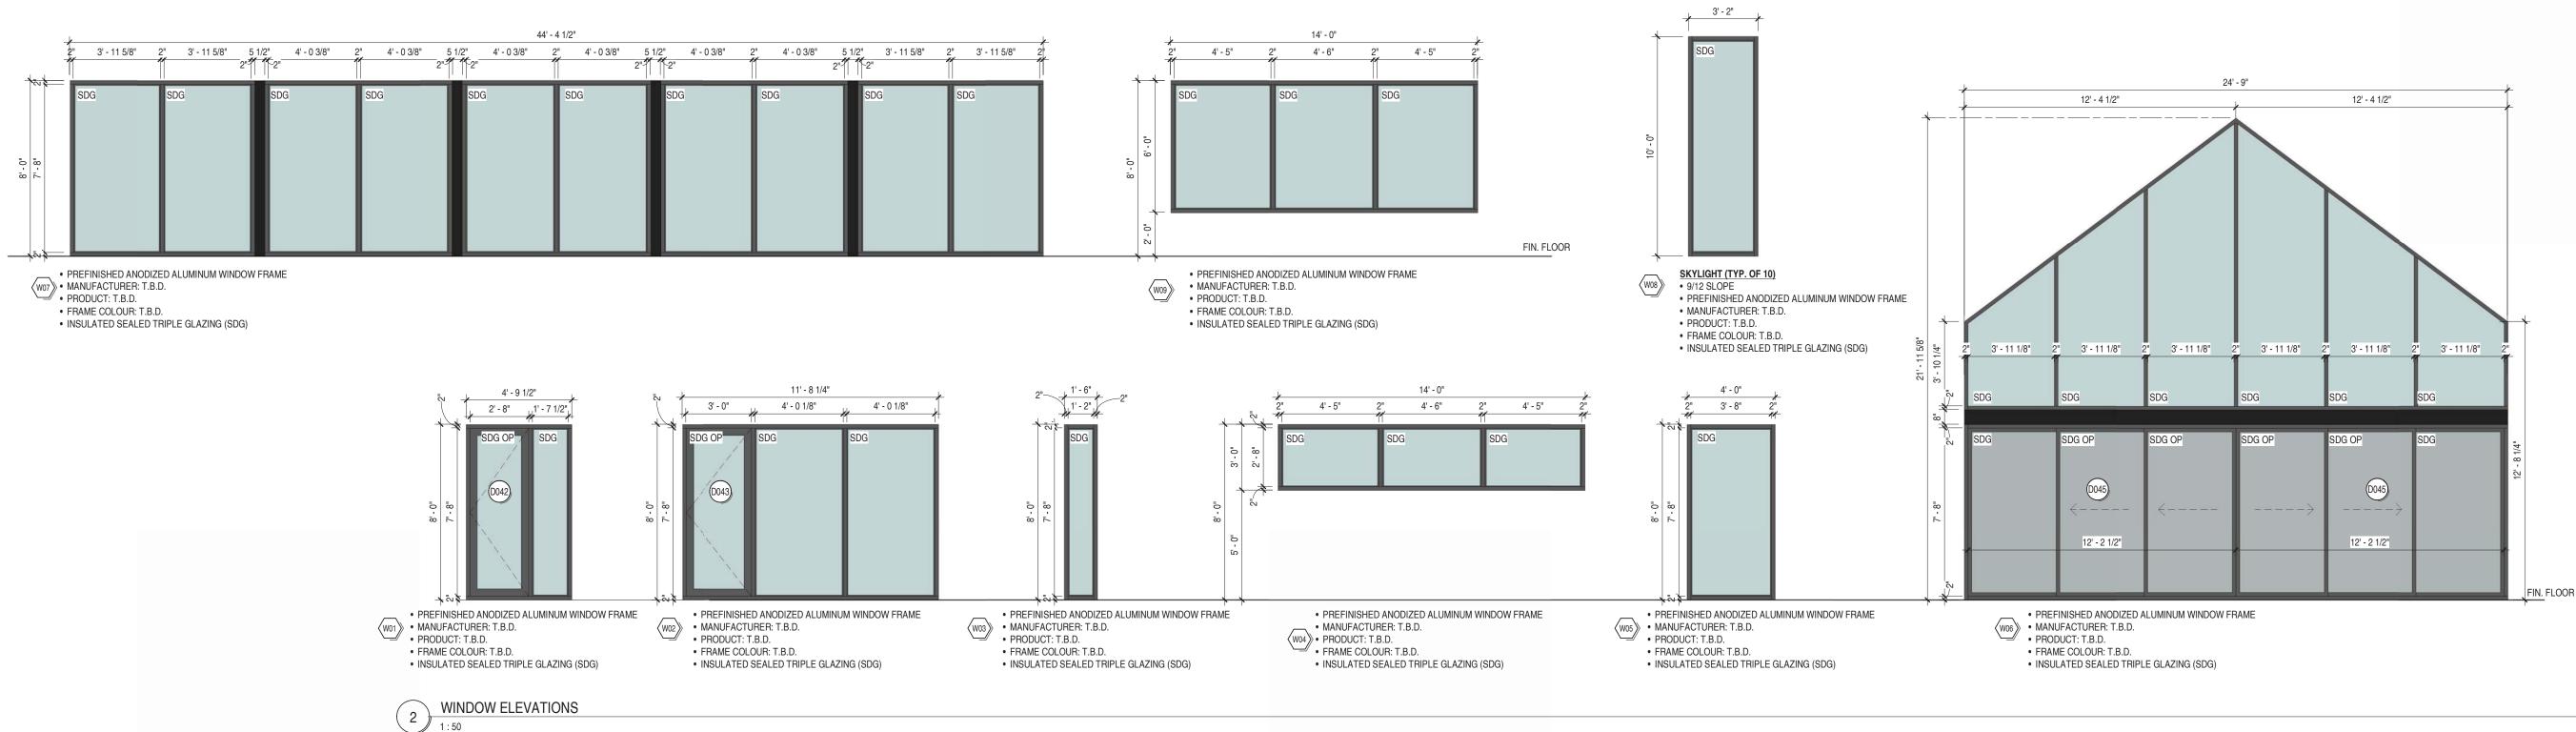


										DOOR	SCHE	EDULE												
				Door	_				Fram	ne				_	_	_	_	_	_	Ha	ardw	/are	;	
Type Mark	Fire Rating	Door Type	Door Material	Door Finish	Qty	Width	Height	Frame Type	Frame Material	Frame Finish	Glazing	Comments	Passage Set	Privacy Set	Dummy Pull	Lock Set	Exit Device	Threshold	Weatherstripping	Door Sweep	Kick Plate	Door Pull	Push Pull	Closer
T/O Ex. Subfir			0.011/2		1.									1										
D040		Х	SC WD	PT.	1	2' - 6"	8' - 0"		WD	PT.	X	TYP. BATH/ENSUITE DOOR												
D041 D042		X	SC WD INSUL.	PT. PT.	1	3' - 0" 2' - 8"	8' - 0" 7' - 8"		WD PREFIN, VINYL	PT. PT.	X SDG.	TYP. CLOSET DOOR ENTRANCE/PATIO DOORS												
D042		^	FIBREGLASS	F1.		2-0	7-0		FREFIN. VINTE	ГІ.	300.	ENTRANCE/FATIO DOOR3												
D043		Х	INSUL. FIBREGLASS	PT.	1	3' - 0"	7' - 8"		PREFIN. VINYL	PT.	SDG.	ENTRANCE/PATIO DOORS												
D044		Х	INSUL. FIBREGLASS	PT.	1	12' - 0"	8' - 0"		PREFIN. VINYL	PT.	SDG.	TRIPLE SLIDING DOOR												
D045		Х	INSUL. FIBREGLASS	PT.	1	12' - 2 1/2"	7' - 8"		PREFIN. VINYL	PT.	SDG.	TRIPLE SLIDING DOOR												

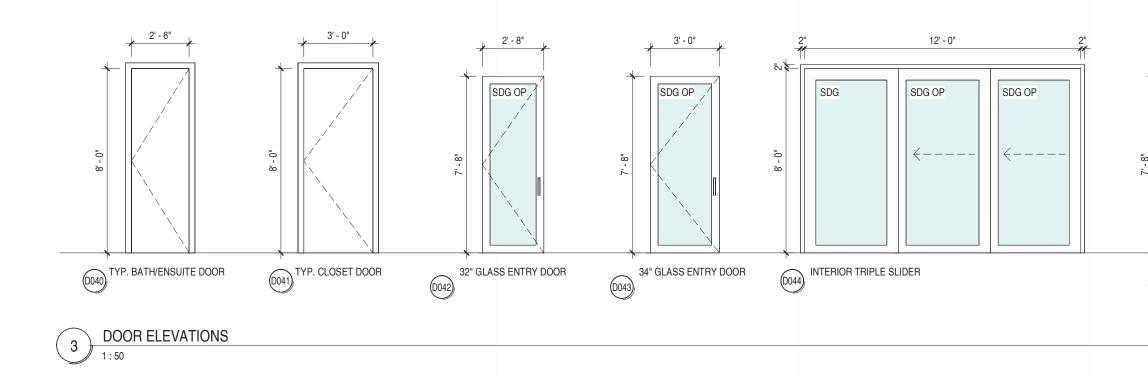

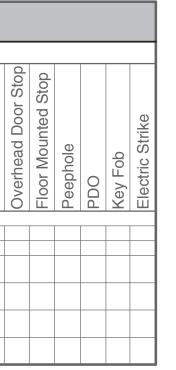

	DOOR GENERAL NOTES	DC	OOR & WINDOW LEG
1.	DOOR AND FRAME SUPPLIER (HOLLOW METAL & ALUMINUM) SHALL PROVIDE ALL REQUIRED CLOSURE TRIMS FOR ALL EXTERIOR FRAMES TO SUIT CORRESPONDING OPENINGS.	AFF AL ANOD CR	ABOVE FINISHED FLOOR ALUMINUM ANODIZED CARD READER
2. 3.	PROVIDE WEATHERSTRIPPING TO ALL EXTERIOR DOORS. PROVIDE SEALANT AROUND ALL EXTERIOR HOLLOW METAL AND ALUMINUM DOOR FRAMES ON EXTERIOR AND INTERIOR SIDES. SEALANT COLOUR TO MATCH FRAMES.	ES FG F/GL	ELECTRIC STRIKE FROSTED GLAZING 'FIRELITE' GLASS
4.	RATED INTERIOR HOLLOW METAL FRAMES TO BE FILLED SOLID WITH MORTAR.	FLR GALV	FLOOR GALVANIZED
5.	EXTERIOR HOLLOW METAL DOORS TO HAVE REINFORCED CORES TO PREVENT WARPING.	GL GWG	GLASS / GLAZING GEORGIAN WIRED GLASS
6.	SHIM CLOSERS ON EXTERIOR DOORS TO PREVENT CUTTING OF WEATHERSTRIPPING.	HC HM	HOLLOW CORE HOLLOW METAL
7.	ALL FIRE RATED DOORS TO HAVE POSITIVE LATCHING MECHANISM HARDWARE IN ACCORDANCE WITH OBC 3.1.8.13.	ID INSUL LINK	REFER TO INTERIOR DESIGN DRAWINGS INSULATED CHAIN LINK
8.	FILL EXTERIOR HOLLOW METAL FRAMES & ALUMINUM FRAMING WITH FOAMED-IN-PLACE INSULATION.	MAG MAS	MAG-LOCK MASONITE
9.	ALUMINUM DOOR HARDWARE TO BE SUPPLIED AND INSTALLED BY ALUMINUM FRAME CONTRACTOR.	MDF MIR MTL	MEDIUM DENSITY FIBREBOARD MIRROR METAL
		O/H OP	OVERHEAD OPERABLE
		PLAM PNT	PLASTIC LAMINATE PAINT(ED)
		PREFIN BB	PREFINISHED RUBBER
		SC SDG	SOLID CORE SEALED DOUBLE GLAZING
		SP SSC STG	GLAZED SPANDREL PANEL SEMI-SOLID CORE
		STG STL STN	SEALED TRIPLE GLAZING STEEL STAINED
		SV	SITE VERIFY
1/2"		TG THSHD	TEMPERED GLAZING THRESHOLD
	SDG OP	VI VT	VINYL VENT
		WD	WOOD

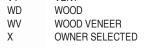

WINDOW WALL TRIPLE SLIDER

<----

 $| \leftarrow ----$

FIN. FLOOR

BUILDING PERMIT

7	Mar 14/25	Issued for Building Permit
6	Dec 03/24	Issued for Budget Costing
3	Nov 4/24	Issued for Coordination
2	Oct 22/24	Issued for Coordination
No.	DATE	ISSUE




1404 Doon Village Road, Kitchener On, N2P 1A5 PROJECT 1404 Doon Village Oasis


1404 Doon Village Road, Kitchener On, N2P 1A5 DRAWING

Door & Window Schedule


PROJECT No. 24-008 PROJECT DATE September 23, 2024	A800
September 23, 2024	AUUU
zschickler	

NDOW LEGEND

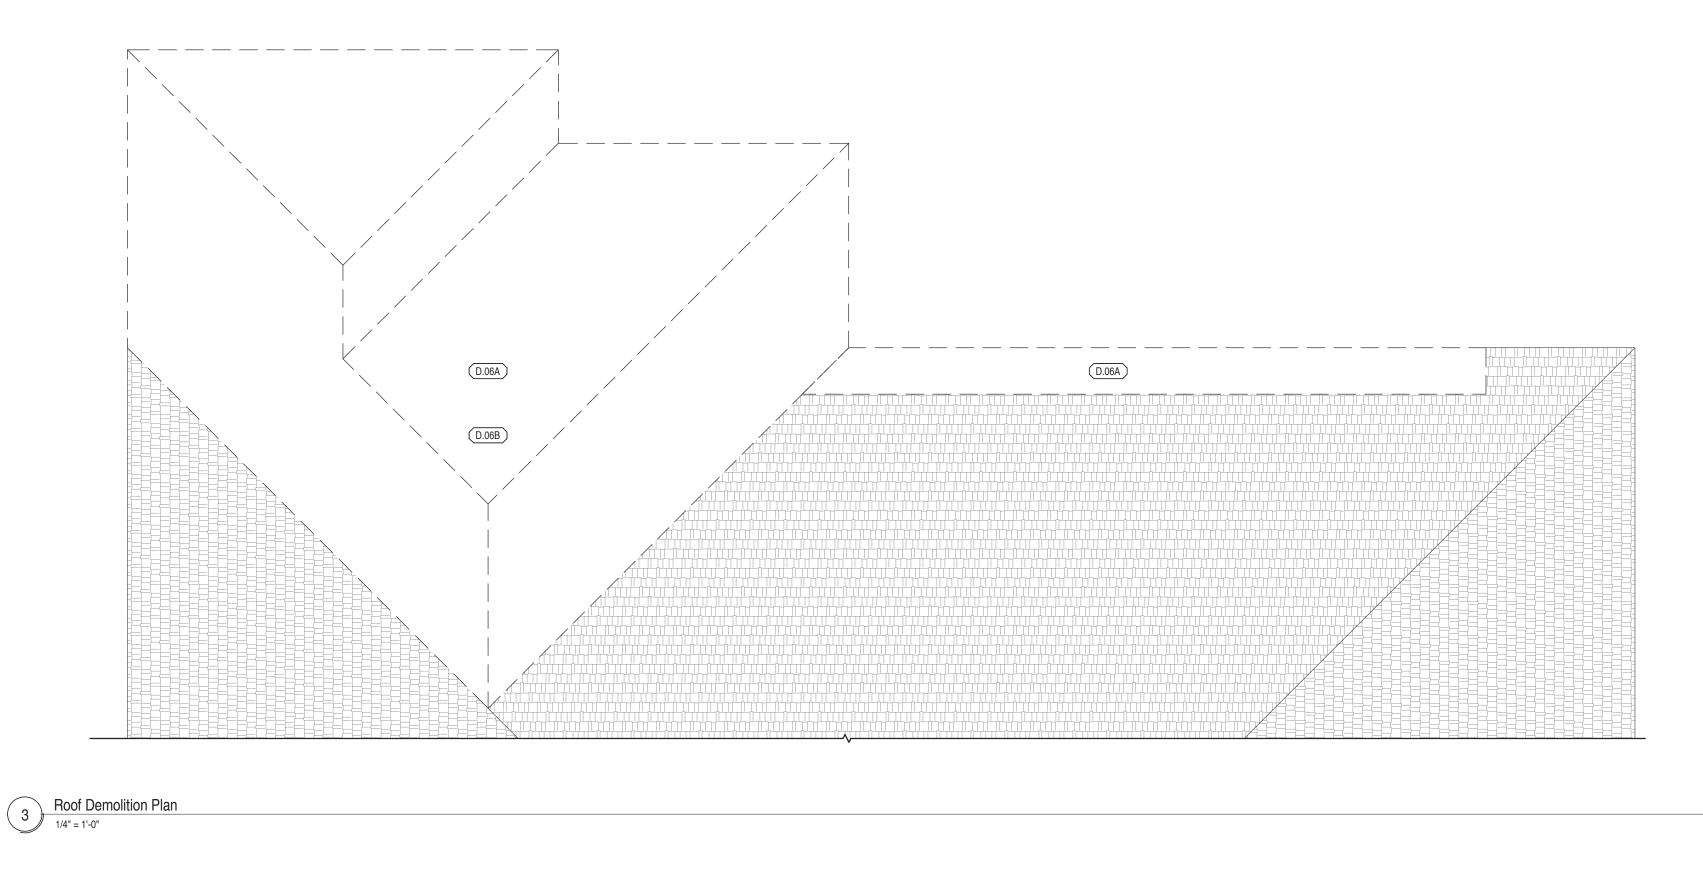

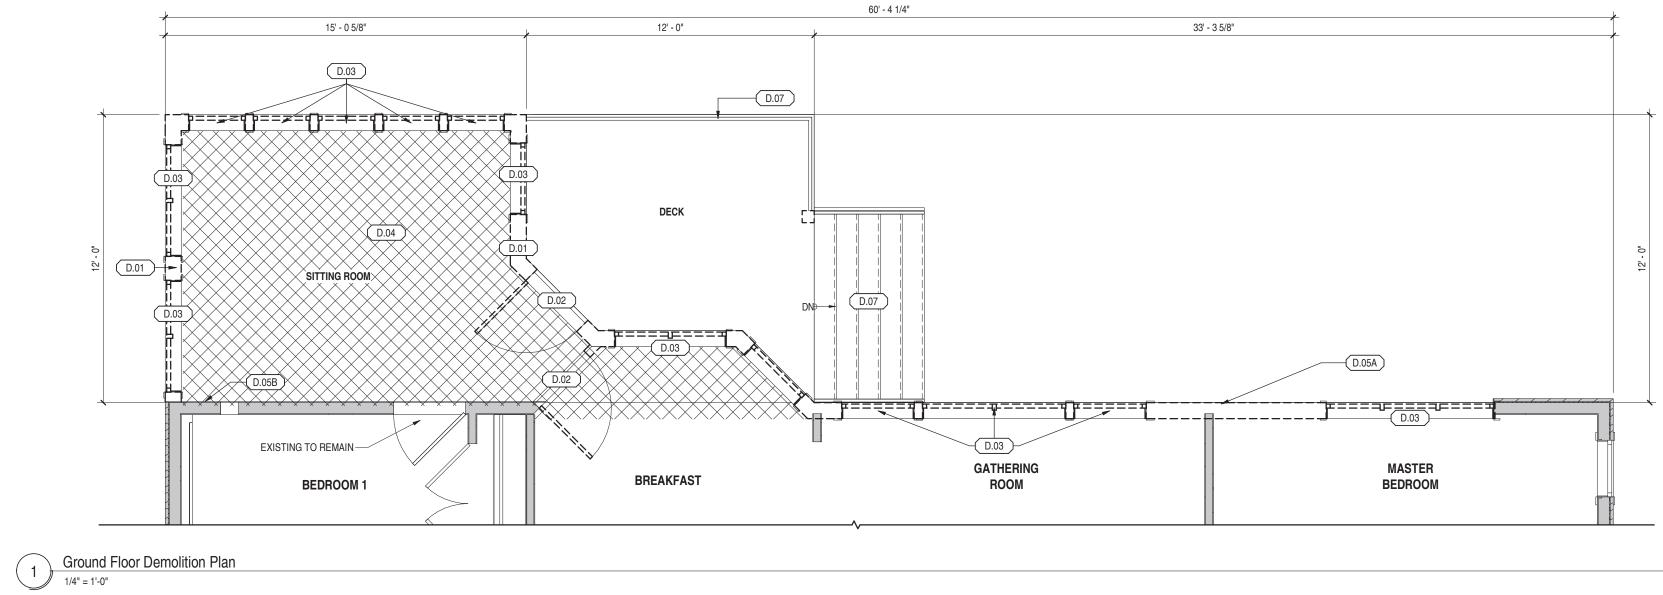



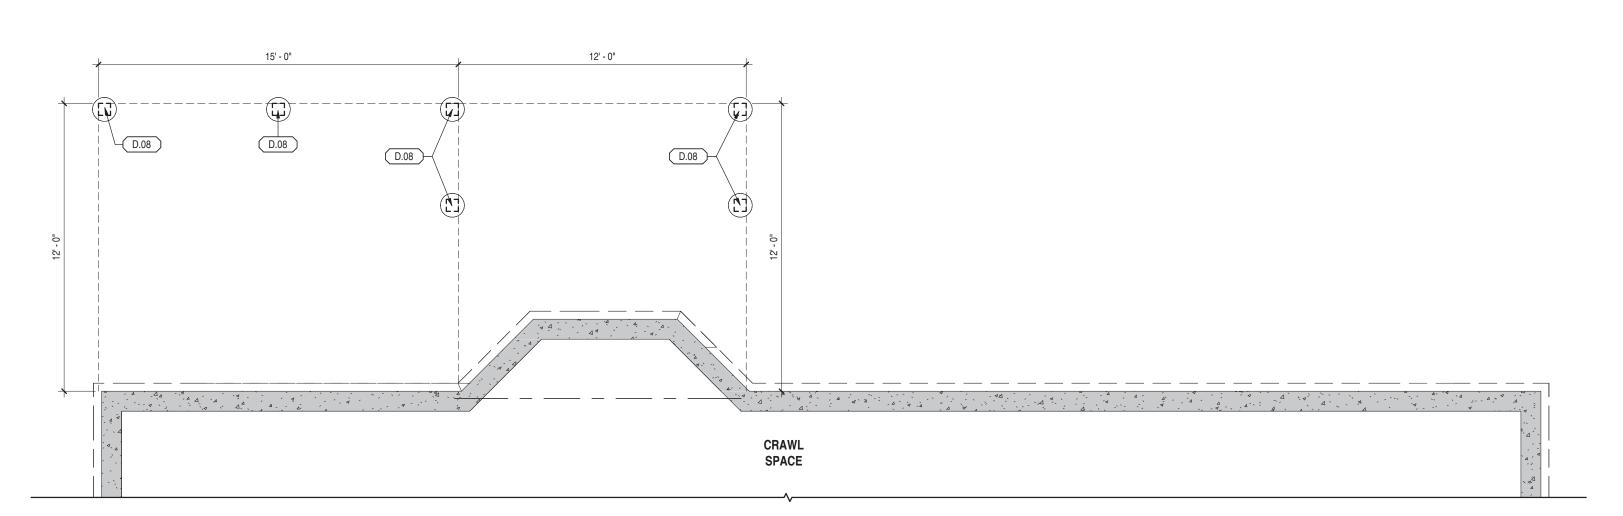



Ι.	WITH ALL REMOVALS, CONTRACTOR TO MAKE GOOD
	ADJACENT REMAINING SURFACES, INCLUDING BUT NOT LIMITED TO, FLOORING BASE, WALLS, CEILING, MILLWORK & FIXTURES.
	IT IS THE SOLE RESPONSIBILITY OF THE CONTRACTOR TO
	DESIGN ALL SHORING AND TEMPORARY BRACING AS PER O.REG. 213/91 AND THE CONTRACTOR SHALL RETAIN AN
	ENGINEER AS REQUIRED. DISPOSE OF REMOVED ITEMS IN A LAWFUL MANNER IN
	ACCORDANCE WITH THE MUNICIPALITY HAVING
	JURISDICTION'S RULES & REGULATIONS.
	ALL EXISTING WALLS TO REMAIN ARE SHOWN SHADED.
	ALL EXISTING WALLS AND ITEMS TO BE REMOVED ARE
	SHOWN DASHED OR AS KEYNOTED WITHIN PLANS. NOT
	ALL ITEMS WILL HAVE A KEYNOTE PROVIDED FOR CONVENIENCE. WHERE DASHED WALLS ARE SHOWN. IT IS
	ASSUMED THAT ALL SUB-ELEMENTS AND SYSTEMS
	WITHIN ARE TO BE DEMOLISHED & REMOVED, UNLESS
	NOTED OTHERWISE.
	OWNER TO HAVE RIGHT OF FIRST REFUSAL FOR ALL
	ITEMS REMOVED. ALL REMOVED ITEMS SHALL BE
	DISPOSED IN ACCORDANCE TO NOTE #3.
	COORDINATE WITH STRUCTURAL, MECHANICAL, &
	ELECTRICAL DRAWINGS FOR ALL RELATED COMPONENTS
	OF DEMOLITION, MODIFICATION, & PROPOSED WORK. REMOVE AND/OR RELOCATE ALL MECHANICAL &
	ELECTRICAL SERVICES/CONNECTIONS AS REQUIRED TO
	ACCOMMODATE DEMOLITION, OR AS A RESULT OF
	DEMOLITION.
	ENSURE ALL FLOOR ARAES ARE FREE OF HAZARDS
	DURING & AFTER DEMOLITION. LEVEL, PATCH, & GRIND
	FLOOR AS REQUIRED TO CREATE SMOOTH SURFACE
	READY TO RECEIVE FINISHED FLOORING.
Э.	ALL EXTERIOR OPENINGS CREATED BY DEMOLITION ARE TO BE HOARDED AND SECURELY FASTENED WITH 16mm
	PLYWOOD SUPPORTED ALL SIDES.
1.	HORIZONTAL EXTERIOR OPENINGS CREATED BY
	DEMOLITION ARE TO BE FURTHER PROTECTED WITH
	WEATHERTIGHT MEMBRANES.
2.	MAINTAIN CLEAN, SAFE, & ORDERLY SITE AT ALL TIMES.
3.	SHOULD MATERIAL RESEMBLING SPRAY/TROWEL APPLIED
	ASBESTOS OR OTHER TOXIC/HAZARDOUS MATERIALS BE
	ENCOUNTERED DURING DEMOLITION, STOP WORK, TAKE
	PREVENTITIVE MEASURES & NOTIFY ARCHITECT AND/OR
	OWNER IMMEDIATELY. DO NOT PROCEED WITHOUT WRITTEN INSTRUCTIONS.

DEMOLI	TION LEGEND
	- DENOTES DOOR TO BE DEMOLISHED
	EXISTING WALL TO REMAIN
	EXISTING WALL TO BE DEMOLISHED
4	KEYNOTE DENOTING THAT ALL RELATED ITEMS WITHIN ROOM ARE TO BE DEMOLISHED

KEYNOTE LEGEND

- D.01 DEMOLISH EXISTING WALL, COORDINATE REMOVALS W/ PROPOSED PLANS & STRUCTURAL PLANS WHERE APPLICABLE.
- D.02 DEMOLISH EXISTING DOOR, FRAME & HARDWARE
- D.03 DEMOLISH EXISTING GLAZING & FRAME D.04 DEMOLISH PORTION OF EXISTING FLOOR (SHOWN
- HATCHED)
- D.05A DEMOLISH EXISTING SIDING. COORDINATE REMOVALS W/ PROPOSED PLANS.
- D.05B SIDING & SHEATHING TO BE ADDED TO EXISTING STUD (MATCH COLOUR TO EXISTING SIDING) D.06A DEMOLISH EXISTING ROOF
- D.06B ADD SHEATHING & SHINGLES TO WHERE EXISTING ROOF IS EXPOSED (MATCH WITH EXISTING SHINGLES)
- D.07 DEMOLISH EXISTING STAIR, GUARDS & HANDRAILS D.08 DEMOLISH EXISTING POST

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		ARCHITECTURE INC



1404 Doon Village Road, Kitchener On, N2P 1A5 PROJECT 1404 Doon Village Oasis

1404 Doon Village Road, Kitchener On, N2P 1A5

Demolition Plans

OWNER

PROJECT No.	
24-008	
PROJECT DATE	
September 23, 2024	D200
DRAWN BY	
zschickler	

From:	richard NEO <richard@neoarchitecture.ca></richard@neoarchitecture.ca>
Sent:	Thursday, March 27, 2025 9:55 AM
То:	Michelle Drake
Subject:	Re: BP 25 106755 - Addition to 1404 Doon Village Road
Attachments:	24-008 Doon Village 1404 Oasis_UDHCD_20250327.pdf

Good morning Michelle,

Please see attached, Draft Exterior Renderings, for the purposes of our Review with the Neighbourhood Representative and to support your Recommendation -

What I hope you will see from these, is the effect of its placement and exterior materials; The proposed addition is rarely visible from the street, obscured as it is by existing trees and the existing house itself.

And where it is visible, only barely and from rather extreme angles, it is like a mirage, where the prior state of the building as well as the established streetscape is much more apparent, preserving the likeness of both.

We firmly believe that this is how we must treat all new buildings, in the shadow of those historic; For every brick or board that goes up *now* in their likeness, makes those bricks and boards that went up *then* worth less.

Sameness, for the sake of preserving uniqueness is counterproductive.

Let me know when the Neighbourhood Representative might be available to discuss, if necessary.

In the meantime, I will prepare our formal Application and improve the legibility of our Drawings, per your suggestion.

Best,

From:	richard NEO <richard@neoarchitecture.ca></richard@neoarchitecture.ca>
Sent:	Wednesday, April 9, 2025 10:09 AM
То:	Michelle Drake
Subject:	Re: 1404 Doon Village Road, heritage Permit Application

Hi Michelle,

- Height of Existing Single-detached Dwelling is: 8m*
- Height of Proposed Addition is: 7.5m*

*Both are measured from Finished Floor Elevation (FFE) rather than Grade, in order to compare using a consistent benchmark; the relative height, of one to the other, is what's relevant.

- Proposed Material for Flat Roof is: ROOF MEMBRANE (PRODUCT: EPDM / TPO, COLOUR: BLACK / GREY)
- Proposed Material for Walls:

PREFINISHED VERTICAL METAL SIDING (MANUFACTURER: METALUNIC / VICWEST, STYLE: MODERNO / BELLARA PLANK, SERIES: WOODSHADE / EXPRESSENCE, COLOUR: URBAN **GREY** 783 QC182535 / RIVER ROCK **GRAY** 18-0254) OR SIMILAR & APPROVED ALTERNATE

• Proposed Material for Gable Roof & Walls is:

PREFINISHED VERTICAL STANDING SEAM METAL SIDING (MANUFACTURER: IDEAL ROODING / AGWAY, STYLE: HERITAGE SERIES STIFFENER RIBS REMOVED / AR STANDING SEAM NO STIFFENER FLUTES, COLOUR: JET **BLACK** TEXTURED ID 60039 / **EBONY** WRINKLE COAT QC 09822) OR SIMILAR & APPROVED ALTERNATE

I will send Updated Drawings that include this information, shortly.

Thank you,

From:richard NEO <richard@neoarchitecture.ca>Sent:Wednesday, April 9, 2025 12:26 PMTo:Michelle DrakeSubject:Re: 1404 Doon Village Road, heritage Permit Application

Hi Michelle,

Please see below, link to Updated Drawings, for your reference:

Verserveryne, Naat Hugette aleks ander (Algebrach tene	myQNAPcloud share link
	I have shared data for you via myQNAPcloud share link service. www.myqnapcloud.com

I realize that you did not actually request the Material for the portion with Flat Roof -Upon further consideration, we would like to exclude this from the HPA if possible.

Ultimately, we may decide to make the Addition all one material, in either **Black or Dark Grey** (Graphite), as per below:

Please confirm this is acceptable.

Thank you,

- Proposed Material for Flat Roof is: ROOF MEMBRANE (PRODUCT: EPDM / TPO, COLOUR: BLACK / GREY)
- Proposed Material for Walls: PREFINISHED VERTICAL METAL SIDING (MANUFACTURER: METALUNIC / VICWEST, STYLE: MODERNO / BELLARA PLANK, SERIES: WOODSHADE / EXPRESSENCE, COLOUR: URBAN GREY 783 QC182535 / RIVER ROCK GRAY 18-0254) OR SIMILAR & APPROVED ALTERNATE
- Proposed Material for Gable Roof & Walls is: PREFINISHED VERTICAL STANDING SEAM METAL SIDING (MANUFACTURER: IDEAL ROODING / AGWAY) (STYLE: HERITAGE SERIES STIFFENER RIBS REMOVED / AR STANDING SEAM NO

STIFFENER FLUTES) (COLOUR: JET **BLACK** TEXTURED ID 60039 / **EBONY** WRINKLE COAT QC 09822) OR SIMILAR & APPROVED ALTERNATE

-OR-

PREFINISHED VERTICAL STANDING SEAM METAL SIDING (MANUFACTURER: IDEAL ROODING / AGWAY) (STYLE: HERITAGE SERIES STIFFENER RIBS REMOVED / AR STANDING SEAM NO STIFFENER FLUTES) (COLOUR: GRAPHITE **GREY** TEXTURED ID 60035 / **GRAPHITE** WRINKLE COAT QC 09821) OR SIMILAR & APPROVED ALTERNATE

Hi Michelle,

- Height of Existing Single-detached Dwelling is: 8m*
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 MODERNO / BELLARA PLANK, SERIES: WOODSHADE / EXPRESSENCE, COLOUR: URBAN
 GREY 783 QC182535 / RIVER ROCK GRAY 18-0254) OR SIMILAR & APPROVED ALTERNATE
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QC 09821) OR SIMILAR & APPROVED ALTERNATE

I will send Updated Drawings that include this information, shortly.

Thank you,

From:	richard NEO <richard@neoarchitecture.ca></richard@neoarchitecture.ca>
Sent:	Thursday, April 10, 2025 9:49 AM
То:	Michelle Drake
Subject:	Re: 1404 Doon Village Road, heritage Permit Application

Good morning Michelle,

The intent behind one (1) single metal cladding material for the addition, would be to simplify four (4) materials total down to just three (3), and in order to further exemplify the differences between new and old.

Also, a darker colour has the effect of diminishing scale (think of a black dress).

However, I would welcome a discussion on the topic with the Neighbourhood Representative and whomever else might have concerns, prior to meeting with the Committee.

Thank you,

From:	richard NEO <richard@neoarchitecture.ca></richard@neoarchitecture.ca>
Sent:	Thursday, April 10, 2025 9:51 AM
То:	Michelle Drake
Subject:	Re: 1404 Doon Village Road, heritage Permit Application

Hey Michelle,

Agway AR Standing Seam is an Alternate.

Ideal Heritage Roofing would be our first choice: https://idealroofing.ca/products/roofing-and-siding/heritage/

The link to the Heritage Roofing brochure seems to be broken - I will forward from our product representative shortly.

Thank you,

From:	richard NEO <richard@neoarchitecture.ca></richard@neoarchitecture.ca>
Sent:	Thursday, April 10, 2025 10:15 AM
То:	Michelle Drake
Subject:	Re: 1404 Doon Village Road, heritage Permit Application

Michelle,

That is correct, Standing Seam (Heritage Series by Ideal, or otherwise) can be applied to Walls as well as Roofs, which is the intent here.

It looks like the Wrinkle Coat finishes/colours are new and not updated on Ideal's literature. But you can see from their website that they are available (see screenshot, below).





HIDDEN FASTENER STEEL ROOF PANELS

HIGH-END ROOFING PANELS FOR COMMERCIAL AND RESIDENTIAL BUILDINGS



TOP-OF-THE-LINE ROOFING

Designed as a roofing panel for prestige, commercial and residential buildings, IDEAL ROOFING's HERITAGE™ **SERIES** steel roof panels bring back the rich traditional style and appearance of standing seam roofs.


- Easy installation: no clips and no seamer necessary
- Save time and labour costs
- Allow for natural movement of roofing system

20¼" (514 MM) OR 16" (406 MM) < → 17/16" 37 MM)

The architecturally pleasing hidden fastener panel can be installed over a solid backing, or over steel or wood purlins through oval slots with **IDEAL ROOFING**'s specially designed fastening screws, allowing for the panel to slide during contraction or expansion.

This product is fabricated with a state-of-the-art roll former and is offered in **IDEAL ROOFING**'s Galvalume AZ150. It is available in our proven top-of-the-line 28, 26 and 24 gauge steel. Combined with the advanced 10,000 Series paint system with Kynar 500[®] resin, this product is available in your choice of 14 attractive colours.

THE HERITAGE™ SERIES offers you the best steel panel product ever made to protect your roof while beautifying and adding true value to your prestige commercial and residential buildings.

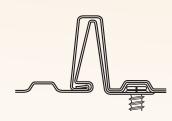

HIDDEN FASTENER PANEL

CANADIAN PATENT: # 1259466 USA PATENT: # 4926608

THE HERITAGE[™] SERIES STEEL PANELS are offered in standard widths of 20¼" or 16" to suit and adapt to any style of sloped roof and to enhance any building architecture.



Stiffener ribs can be removed when specified.

STRUCTURAL PROPERTIES

	TOTAL NOMINAL	CORE NOMINAL	MOMENT	MOM RESIST		SUPPORT RESIST	
	THICKNESS (INCH)	THICKNESS (INCH)	OF INERTIA (IN-4)	MID-SPAN (IN-LB)	SUPPORT (IN-LB)	END (LB)	INTERIOR (LB)
ĺ	.018	.016	.0362	656	553	137	242
	.021	.018	.0447	699	816	174	306
	.026	.024	.0472	838	720	209	411

*INCLUDES AN IMPORTANCE FACTOR OF 1.0, LIVE LOAD FACTOR OF 1.5, AND BASED ON A BEARING LENGTH OF 1.5"

MAXIMUM UNIFORMLY DISTRIBUTED LOADS (POUNDS/SQUARE FOOT)

SPAN	SPAN (INCHES)	28 GAUGE (.018")		26 GAUGE (.021")		24 GAUGE (.026")	
CONDITION		в	D	в	D	в	D
SINGLE	18	150	625	232	869	248	916
	24	98	264	136	366	140	386
	30	63	135	87	188	89	198
DOUBLE	18	101	1500	163	2085	213	2198
	24	76	633	117	879	120	927
	30	52	324	75	450	77	475
TRIPLE	18	114	1181	184	1642	247	1731
	24	85	498	138	693	150	730
	30	65	255	93	355	96	374

B = LOAD CAPACITY BASED ON STRENGTH MINIMUM YIELD STRESS Fy = 33,000 P.S.I. **D** = DEFLECTION BASED ON L/240

MAXIMUM WORKING STRESS FB = 20,625 P.S.I. YOUNG'S MODULUS (E) = 29,500,000 P.S.I.

AVAILABLE MATERIALS / 10,000 SERIES, KYNAR 500®

26 GA. (.026")** 24 GA.	(.021")*	(.018")** 28 GA.	THICKNESS & GAUGE
•	•	•	MIDNICHT BLACK ID 193
•	•	•	BRONZE ID 8981
•	•	•	CHOCOLATE BROWN ID 196
•	•	•	MARITIME GREY ID 690
	•	•	GREY BERRY ID 3659
•			NAVY BLUE ID 198
	•	•	TWILICHT BLUE ID 3644
		•	HARTFORD GREEN ID 8980
•	•	•	WINTER GREEN ID 3651
•			PATINA GREEN ID 201
		•	CORDOVAN ID 3643
		•	CRANBERRY RED ID 7437
•	•		CLASSIC COPPER ID 9919
•	•		BRICHT SILVER ID 10637
•	•		GALVALUME PLUS

*16" WIDE ONLY **20 1/4" WIDE ONLY

PRE-PAINTED GALVALUME AZ150 STEEL ASTM A792 SS, GRADE 33, 10,000 SERIES, KYNAR 500[®]. GAUGES: 28 (.018" THICK), 26 (.021" THICK) AND 24 (.026" THICK).

MILL FINISH GALVALUME PLUS ASTM-A792 SS, GRADE 33, AZ180 GAUGES: 26 (.021" THICK) AND 24 (.026" THICK).





AVAILABLE COLOURS

10,000 Series, Kynar 500®





HIDDEN FASTENER STEEL ROOF PANEL



ENVIRONMENT-FRIENDLY. THIS PRODUCT IS ENTIRELY RECYCLABLE.



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Dideal roofing

Head Office 1418 Michael Street Ottawa, ON K1B 3R2 Tel.: 613-746-3206 **Toll Free: 1-800-267-0860** Fax: 613-746-0445 info@idealroofing.ca

Toronto Manufacturing Facility 223 Corporation Drive Brampton, ON L6S 6G5 Tel.: 905-792-4354 Toll Free: 1-877-792-4354 Fax: 905-792-7740

Moncton Manufacturing Facility 650 Frenette Avenue Moncton, NB E1H 2S7 Tel.: 506-857-3888 Toll Free: 1-833-753-0051 Fax: 506-857-8823


Quebec Regional Office 5240 Wilfrid-Hamel Boulevard Québec, QC G2E 2G9 Tel.: 418-874-0010 **Toll Free: 1-888-313-0010** Fax: 418-874-0011

www.idealroofing.com

Printed in the USA / September 2023

FLASHINGS AND TRIMS

Optional flashings and details are available in the Installation Guide.

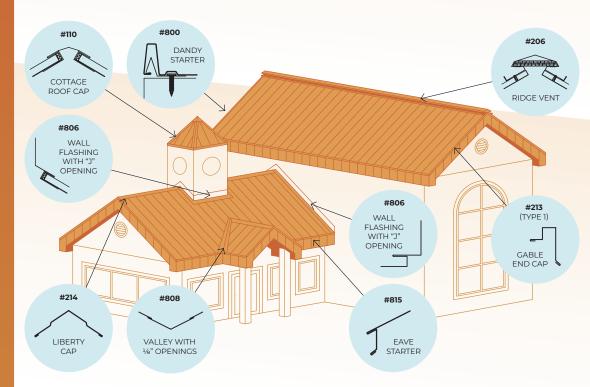

#110	COTTAGE ROOF CAP (24" GIRTH)	#206	RIDGE VENT	#213 TYPE 1	GABLE END CAP (A + B + 5¾" = GIRTH)
	22122"				1" 3/6" 5/6" 3/4"
#214	LIBERTY CAP (15" GIRTH)	#806	WALL FLASHING WITH "J" OPENING (18" GIRTH)	#808	VALLEY WITH ⅔" OPENINGS
135°~	3 ¹ / ₂ " 135° ¹ / ₂ " 1/ ₂ "	19 43	ула страна и страна и удели страна и страна удели страна и страна удели страна и страна удели страна и страна удели страна и страна удели страна и страна удели страна и страна и страна и с и страна и стр	PRE-P/	CALVALUME, 30" FLASHING AINTED 10,000 SERIES, 28" FLASHING
#815	EAVE STARTER (9" GIRTH)	С	FOAM AND METAL LOSURES FOR RIDGE		END PLUG
◀ 3/4 1⁄2			20¼″ 		